

I have reviewed the drawings and talked with David Jean and we have one concern on the drawings. Sheet SD-01 The stormwater basin was modified as discussed. We appreciate the changes in the design that were made. The new proposed configuration looks like it should work well. On the west side of the pond the contours end at what we are assuming is a daylight line with the existing ground. There is a paved driveway between that and the private lots to the west. We need to see how this will interface with the pavement. Specifically, how wide will the remaining pavement be? I am guessing that the pavement will be reduced in width to fit this in. And secondly, how far off the pavement will the drop into the basin be located? We need to determine if some sort of barrier is going to need to be constructed between the driveway and the down slope into the basin.

We also want to make sure that Lee understand that those sections of the street in the subdivision that are on fill will require a very specific construction and testing regimen. The fill material will need to be placed in 6" lifts and will need to meet 95% compaction. The City will want to see compaction testing every 100 feet, near the center and out near both sides of the fill. The testing shall occur after the first foot of material is placed and compacted and then again after the second foot of material is placed and compacted. If the method is successful with consistently passing tests the testing rate can be relaxed to two foot intervals in the sections that are six feet or deeper up to the last two feet of depth which will require testing every foot of depth to the surface. If the material being used changes, new proctors will be required and the testing frequency will need to go back to 1 foot intervals until consistent favorable compaction tests are achieved. When this project goes into construction we will sit down with the contractor and specifically determine where the different frequencies of testing will occur.

To make sure the material is placed in 6" lifts the City will require that the elevation of the 6" lifts will be measured and documented by the contractor at similar frequency (every 100 feet) and pattern (center and both sides) as the compaction testing.

Thanks,

**SHAY STARK – PLANNER/DESIGNER**

I don't see a problem with them going on Tuesdays agenda as long as the question of the location and width of the remaining driveway and its distance from the edge of the basin are clarified so that a barrier can be included in the project if it is needed. This can be a condition of approval and we can resolve it before construction occurs. I just want to make sure it is addressed. This issue has come up because of the requested changes being made to the basin which now encroaches further into the driveway area. There is not a problem with the encroachment. We just need to make sure the remaining driveway is an adequate width and that there are appropriate safety measures taken along the edge of basin so that we don't have someone drive off the edge and end up in the basin.

I also would like the City Council discussion to clarify with the Developer the restoration of landscaping in the basin. It just needs to be on the record and we may want to include it in the Development Agreement.

Thanks,

**SHAY STARK – PLANNER/DESIGNER**

# DRYLAND SUBDIVISION

## A RESIDENTIAL SUBDIVISION

### ELK RIDGE, UTAH

### FINAL PLAN SET


### JANUARY 2021

SHEET NO. 1

### -SHEET INDEX-

| SHEET | SHEET NAME  |
|-------|---|
| 1     | COVER   |
| 2     | FINAL PLAT  |
| 3     | UTILITY & INDEX   |
| 4     | GRADING   |
| 5     | EXISTING TOPOGRAPHY   |
| 6     | EROSION CONTROL   |
| 7     | RE-VEGETATION/RETENTION   |
| PP-01 | PLAN & PROFILE - HANNAH STREET - STA. 15+50 TO STA. 19+88.29    |
| PP-02 | PLAN & PROFILE - HANNAH STREET - STA. 10+00 TO STA. 15+50       |
| PP-03 | PLAN & PROFILE - AMY WAY - STA. 10+00 TO STA. 13+50             |
| PP-04 | PLAN & PROFILE - DRYLAND CIRCLE - STA. 10+00 TO STA. 12+19.92   |
| PP-05 | PLAN & PROFILE - GOLDEN EAGLE WAY - STA. 13+50 TO STA. 17+00    |
| PP-06 | PLAN & PROFILE - GOLDEN EAGLE WAY - STA. 10+00 TO STA. 13+50    |
| SD-01 | PLAN & PROFILE - OFFSITE STORM DRAIN - STA. 17+00 TO STA. 21+00 |
| DT-01 | DETAIL SHEET  |
| DT-02 | DETAIL SHEET  |
| DT-03 | DETAIL SHEET  |
| DT-04 | DETAIL SHEET  |
| DT-05 | DETAIL SHEET  |
| BM-01 | BEST MANAGEMENT PRACTICES                                       |
| BM-02 | BEST MANAGEMENT PRACTICES                                       |
| BM-03 | BEST MANAGEMENT PRACTICES                                       |

**NOTES:**  
CONTRACTOR RESPONSIBLE TO CONTACT BLUESTAKES PRIOR TO CONSTRUCTION. ANY DISCREPANCIES BETWEEN PLANS AND ACTUAL FIELD CONDITIONS TO BE REPORTED TO ENGINEER.

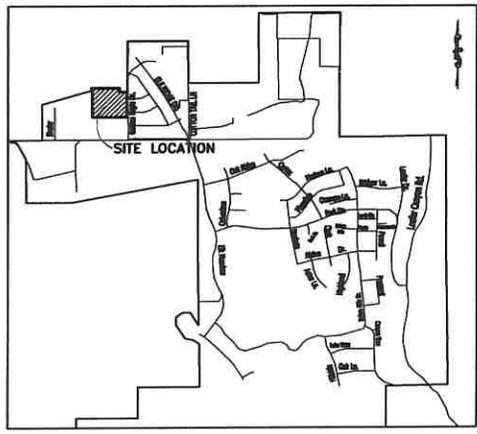

**VICINITY MAP**  
-NTS-

**OWNER/DEVELOPER**  
LEE HASKELL  
901 GOOSENEST DR.  
ELK RIDGE, UTAH  
801-372-0139

**DATA TABLE**  
ZONING=R-20  
TOTAL ACREAGE=11.10  
TOTAL # OF LOTS=15  
TOTAL ACREAGE OF LOTS=9.31  
TOTAL ACREAGE IN ROADS=1.79  
TOTAL LOTS/ACRE=1.35



**LEGEND**  
(APPLIES TO ALL SHEETS)

|  |                                  |
|--|----------------------------------|
|  | SECTION CORNER                   |
|  | FOUND ALUMINUM CAP               |
|  | SET 5/8" INCH PIN                |
|  | CALCULATED POINT, NOT SET        |
|  | EXISTING POWER POLE              |
|  | PROPOSED STREET LIGHT            |
|  | PROPOSED FIRE HYDRANT            |
|  | PROPOSED SIGN                    |
|  | PROPOSED STREET SIGN             |
|  | PROPERTY BOUNDARY                |
|  | CENTERLINE                       |
|  | RIGHT-OF-WAY LINE                |
|  | LOT LINE                         |
|  | SECTION LINE                     |
|  | EASEMENT                         |
|  | EXISTING DEED LINE               |
|  | EDGE OF PAVEMENT                 |
|  | EXISTING OVERHEAD POWER          |
|  | EXISTING FENCE LINE              |
|  | EXISTING DITCH                   |
|  | EXISTING SANITARY SEWER MANHOLE  |
|  | PROPOSED STORM DRAIN MANHOLE     |
|  | PROPOSED PVC 15-36 SEWER MANHOLE |
|  | PROPOSED CULINARY WATERLINE      |
|  | PROPOSED PRESSURIZED IRRIGATION  |


DRYLAND SUBDIVISION  
COVER

ELK RIDGE, UTAH



PHONE: 801-465-0666  
FAX: 801-465-0100  
946 E 800 N SUITE A  
SPANISH FORK, UT 84660



(DATE STAMP)

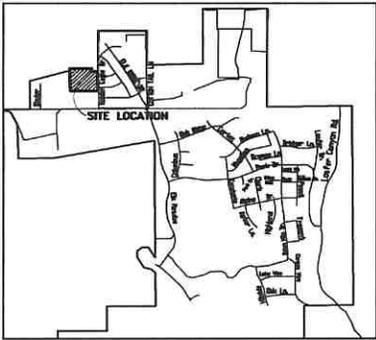

VICINITY MAP

| CURVE TABLE |        |        |             |               |           |       |        |        |             |               |            |
|-------------|--------|--------|-------------|---------------|-----------|-------|--------|--------|-------------|---------------|------------|
| CURVE       | RADIUS | LENGTH | CHORD DIST. | CHORD BRG.    | DELTA     | CURVE | RADIUS | LENGTH | CHORD DIST. | CHORD BRG.    | DELTA      |
| C1          | 15.00  | 23.56  | 21.21       | N 45°00'00" W | 90°00'00" | C12   | 60.00  | 78.79  | 73.25       | S 16°11'05" E | 75°14'05"  |
| C2          | 15.00  | 14.40  | 13.86       | N 27°30'31" F | 55°01'01" | C13   | 60.00  | 111.63 | 96.21       | N 72°54'02" E | 106°35'41" |
| C3          | 60.00  | 72.92  | 68.52       | S 20°11'53" W | 69°38'16" | C14   | 60.00  | 74.50  | 69.80       | N 19°26'53" W | 71°08'16"  |
| C4          | 60.00  | 78.94  | 73.37       | S 52°18'37" E | 75°22'46" | C15   | 15.00  | 14.40  | 13.86       | S 27°30'31" E | 55°01'01"  |
| C5          | 60.00  | 67.36  | 63.88       | N 48°16'53" E | 64°19'17" | C16   | 15.00  | 19.99  | 18.54       | S 38°10'09" W | 76°20'19"  |
| C6          | 60.00  | 74.50  | 69.80       | N 19°26'53" W | 71°08'16" | C17   | 178.00 | 88.86  | 87.94       | N 62°02'13" F | 28°36'12"  |
| C7          | 15.00  | 14.40  | 13.86       | S 27°30'31" E | 55°01'01" | C18   | 122.00 | 88.38  | 86.46       | S 68°29'17" W | 41°30'20"  |
| C8          | 15.00  | 23.56  | 21.21       | N 45°00'00" W | 90°00'00" | C19   | 15.00  | 23.56  | 21.21       | N 45°45'33" W | 90°00'00"  |
| C9          | 15.00  | 23.56  | 21.21       | N 45°00'00" W | 90°00'00" | C20   | 122.00 | 89.99  | 87.97       | N 68°52'03" E | 42°15'53"  |
| C10         | 15.00  | 14.40  | 13.86       | N 27°30'31" E | 55°01'01" | C21   | 178.00 | 128.95 | 126.14      | S 68°29'17" W | 41°30'20"  |
| C11         | 60.00  | 35.17  | 34.67       | S 38°13'29" W | 33°35'04" | C22   | 15.00  | 23.56  | 21.21       | N 44°14'27" E | 90°00'00"  |
|             |        |        |             |               |           | C23   | 60.00  | 10.01  | 10.00       | N 85°13'16" E | 9°33'29"   |

HASKELL PROPERTIES LLC  
30-073-0248

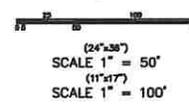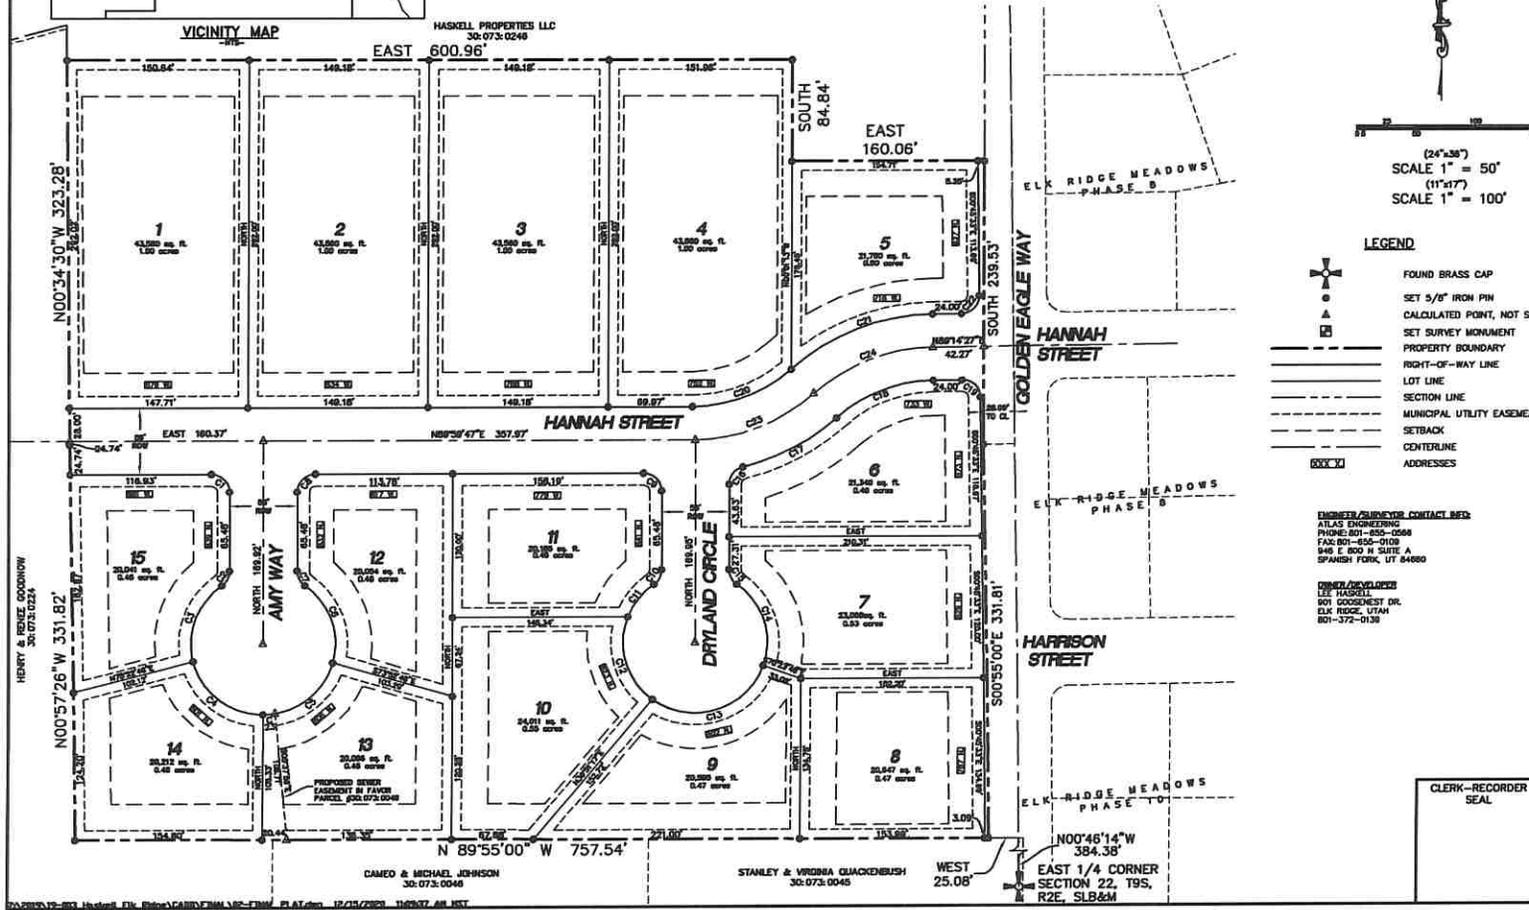

- LEGEND**
- FOUND BRASS CAP
  - SET 5/8" IRON PIN
  - CALCULATED POINT, NOT SET
  - SET SURVEY MONUMENT
  - PROPERTY BOUNDARY
  - RIGHT-OF-WAY LINE
  - LOT LINE
  - SECTION LINE
  - MUNICIPAL UTILITY EASEMENT
  - SETBACK
  - CENTERLINE
  - ADDRESSES

**REGISTERED SURVEYOR CONTACT INFO:**  
 ATLAS ENGINEERING  
 PHONE: 801-850-0088  
 FAX: 801-850-0108  
 848 E. 900 N. SUITE A  
 SPANISH FORK, UT 84660

**DRAWN/DEVELOPED BY:**  
 LEE HASKELL  
 601 DOCKENHAST DR.  
 ELK RIDGE, UTAH  
 801-372-0130

CAMEO & MICHAEL JOHNSON  
30-073-0048

STANLEY & VIRGINIA QUACKENBUSH  
30-073-0045

WEST 25.08'  
 EAST 1/4 CORNER  
 SECTION 22, T9S,  
 R2E, SLB&M

**SURVEYOR'S CERTIFICATE**

I, BARRY L. PRETTYMAN DO HEREBY CERTIFY THAT I AM A PROFESSIONAL LAND SURVEYOR, AND THAT I HOLD CERTIFICATE NO. 188408 AS PRESCRIBED UNDER THE LAWS OF THE STATE OF UTAH. I FURTHER CERTIFY BY AUTHORITY OF THE OWNERS, I HAVE MADE A SURVEY OF SAID TRACT OF LAND SHOWN ON THIS PLAT AND DESCRIBED BELOW, AND HAVE SUBDIVIDED SAID TRACT OF LAND INTO LOTS, STREETS, AND EASEMENTS AND THAT THE SAME HAS BEEN CORRECTLY SURVEYED AND STAKED ON THE GROUND AS SHOWN ON THIS PLAT AND THAT THIS IS TRUE AND CORRECT.

SURVEYOR \_\_\_\_\_ DATE \_\_\_\_\_

**BOUNDARY DESCRIPTION**

BEGINNING AT A POINT WHICH LIES N00°48'14"W 384.38 FEET AND WEST 25.08 FEET FROM THE EAST QUARTER CORNER OF SECTION 22, TOWNSHIP 9 SOUTH, RANGE 2 EAST, SALT LAKE BASE AND MERIDIAN; AND RUNNING THENCE N09°55'00"W 757.54 FEET TO AN EXISTING FENCE; THENCE N00°57'28"W 331.82 FEET ALONG SAID FENCE; THENCE N00°34'30"W 323.28 FEET; THENCE EAST 600.96 FEET; THENCE SOUTH 84.84 FEET; THENCE EAST 180.06 FEET; THENCE SOUTH 239.53 FEET; THENCE S00°55'00"E 331.81 FEET TO THE POINT OF BEGINNING, CONTAINING 11.10 ACRES.

**OWNER'S DEDICATION**

KNOW ALL MEN BY THESE PRESENTS THAT WE, ALL OF THE UNDERSIGNED OWNERS OF ALL THE PROPERTY DESCRIBED IN THE SURVEYOR'S CERTIFICATE HEREON AND SHOWN ON THIS MAP, HAVE CAUSED THE SAME TO BE SUBDIVIDED INTO LOTS, STREETS, AND EASEMENTS AND DO HEREBY DEDICATE THE STREETS, EASEMENTS AND OTHER PUBLIC AREAS AS INDICATED HEREON TO ELK RIDGE CITY FOR PERPETUAL USE OF THE PUBLIC.  
 IN WITNESS WHEREOF WE HAVE HEREUNTO SET OUR HANDS THIS DAY OF \_\_\_\_\_ A.D. 2020.

MEMBER: \_\_\_\_\_  
 MEMBER: \_\_\_\_\_  
 MEMBER: \_\_\_\_\_  
 MEMBER: \_\_\_\_\_

**ACKNOWLEDGMENT**

STATE OF UTAH  
 COUNTY OF UTAH  
 ON THE \_\_\_\_\_ DAY OF \_\_\_\_\_, A.D. 2020 PERSONALLY APPEARED BEFORE ME \_\_\_\_\_ THE SIGNERS OF THE FOREGOING DEDICATION WHO DULY ACKNOWLEDGED TO ME THAT THEY DID EXECUTE THE SAME.

NOTARY PUBLIC IN THE STATE OF UTAH  
 COMMISSION NUMBER / EXPIRES \_\_\_\_\_ NOTARY PUBLIC PRINTED NAME \_\_\_\_\_

**ACCEPTANCE BY LEGISLATIVE BODY**


THE \_\_\_\_\_ OF \_\_\_\_\_ COUNTY OF UTAH, APPROVES THIS SUBDIVISION AND HEREBY ACCEPTS THE DEDICATION OF ALL STREETS, EASEMENTS, AND OTHER PARCELS OF LAND INTENDED FOR PUBLIC PURPOSES FOR THE PERPETUAL USE OF THE PUBLIC THIS \_\_\_\_\_ DAY OF \_\_\_\_\_, A.D. 2020.

APPROVED \_\_\_\_\_ ATTEST \_\_\_\_\_  
 MAYOR \_\_\_\_\_ CLERK-RECORDER \_\_\_\_\_

**DRYLAND SUBDIVISION PLAT "A"**

ELK RIDGE CITY, UTAH COUNTY, UTAH  
 CONTAINING 15 LOTS AND 11.10 ACRES  
 LOCATED IN THE NORTHEAST QUARTER OF SECTION 22, TOWNSHIP 9 SOUTH, RANGE 2 EAST, SALT LAKE BASE AND MERIDIAN, UTAH COUNTY, UTAH.

|                     |                 |                    |                      |
|---------------------|-----------------|--------------------|----------------------|
| CLERK-RECORDER SEAL | SURVEYOR'S SEAL | NOTARY PUBLIC SEAL | UTAH COUNTY RECORDER |
|---------------------|-----------------|--------------------|----------------------|

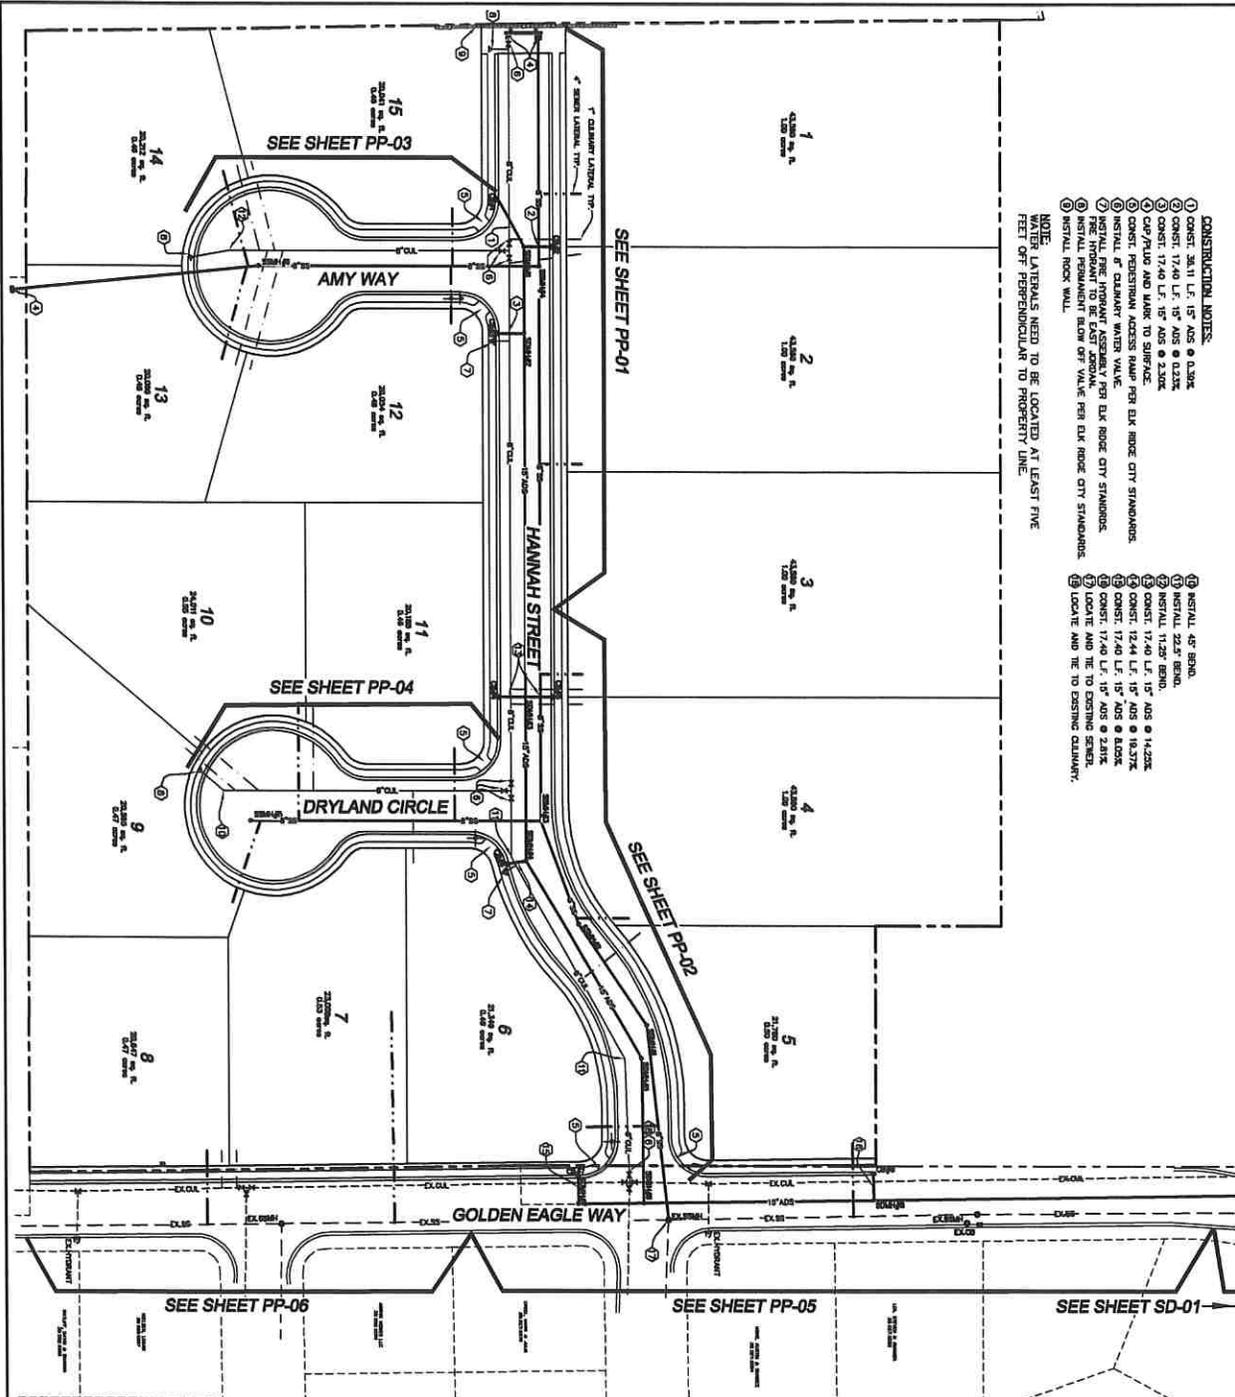

- CONSTRUCTION NOTES:**
- 1) CONST. 30" I.D. 15' A/S @ 2.0%.
  - 2) CONST. 17.40' I.D. 15' A/S @ 2.0%.
  - 3) CONST. 17.40' I.D. 15' A/S @ 2.0%.
  - 4) CONST. 17.40' I.D. 15' A/S @ 2.0%.
  - 5) CONST. 17.40' I.D. 15' A/S @ 2.0%.
  - 6) CONST. 17.40' I.D. 15' A/S @ 2.0%.
  - 7) CONST. 17.40' I.D. 15' A/S @ 2.0%.
  - 8) CONST. 17.40' I.D. 15' A/S @ 2.0%.
  - 9) CONST. 17.40' I.D. 15' A/S @ 2.0%.
  - 10) CONST. 17.40' I.D. 15' A/S @ 2.0%.
  - 11) CONST. 17.40' I.D. 15' A/S @ 2.0%.
  - 12) CONST. 17.40' I.D. 15' A/S @ 2.0%.
  - 13) CONST. 17.40' I.D. 15' A/S @ 2.0%.
  - 14) CONST. 17.40' I.D. 15' A/S @ 2.0%.
  - 15) CONST. 17.40' I.D. 15' A/S @ 2.0%.
- NOTE:**  
 1) LATERALS NEED TO BE LOCATED AT LEAST FIVE FEET OFF PERPENDICULAR TO PROPERTY LINE.

**LEGEND**

- DESTROY POWER POLE
- PROPOSED FIRE HYDRANT
- PROPOSED STREET LIGHT
- DESTROY FIRE HYDRANT
- DESTROY WATER VALVE
- DESTROY STREET LIGHT
- PROPOSED STOP SIGN
- PROPOSED STREET SIGN
- DESTROY POWER BOX
- DESTROY TELEPHONE BOX
- DESTROY MET BOX
- PROPERTY BOUNDARY
- CENTERLINE
- RIGHT-OF-WAY LINE
- LOT LINE
- SECTION LINE
- EASEMENT
- DESTROY POWER LINE
- DESTROY OVERHEAD POWER
- DESTROY WASTEWATER SEWER/WASTEWATER
- DESTROY STORM DRAIN W/4"1
- DESTROY WATER
- PROPOSED STORM DRAIN
- PROPOSED P.C. 30"-30" STORM W/4"1
- PROPOSED CULVERT W/18"1
- PROPOSED PERMISSORIZED INVOLUTION - C200 P.C.

**VICINITY MAP**  
-NTS-

**ATLAS ENGINEERING LLC.**  
 PHONE: 801-655-0566  
 FAX: 801-655-0109  
 946 E 800 N SUITE A  
 SPANISH FORK, UT 84668



UTILITY & INDEX

DRYLAND SUBDIVISION  
ELK RIDGE, UTAH

SHEET NO.


3

| NO. | REVISIONS | BY | DATE |
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**LEGEND**

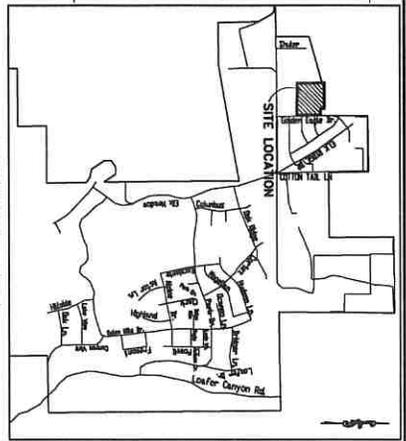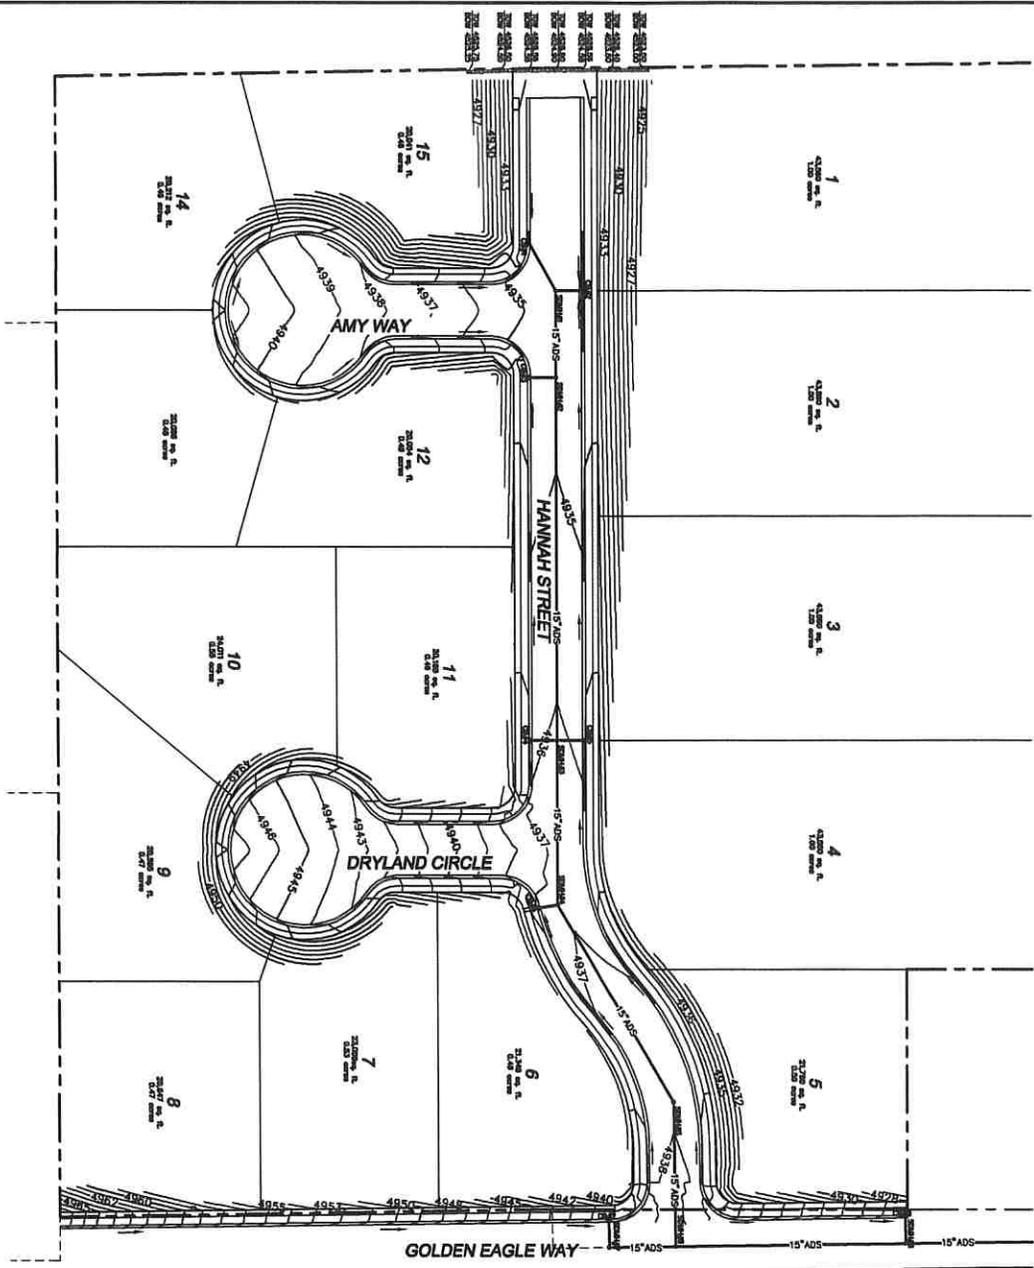- EXISTING POWER POLE
- PROPOSED FIRE HYDRANT
- PROPOSED STREET LIGHT
- EXISTING FIRE HYDRANT
- EXISTING WATER VALVE
- EXISTING STREET LIGHT
- PROPOSED STOP SIGN
- PROPOSED STREET SIGN
- EXISTING POWER BOX
- EXISTING TELEPHONE BOX
- EXISTING MAIL BOX
- PROPERTY BOUNDARY
- CENTERLINE
- RIGHT-OF-WAY LINE
- LOT LINE
- SECTION LINE
- EASEMENT
- EXISTING POWER LINE
- EXISTING OVERHEAD POWER
- EXISTING SANITARY SEWER W/AMNHOLE
- EXISTING STORM SEWER W/AM
- EXISTING WATER
- PROPOSED STORM SEWER
- PROPOSED PVE 30" SDR-35 SEWER W/AM
- PROPOSED CULINARY W/INDOLE
- PROPOSED PRESSURIZED IRRIGATION - 6" SDR PVC



**ATLAS ENGINEERING LLC.**  
 PHONE: 801-655-0566  
 FAX: 801-655-0109  
 948 E 800 N SUITE A  
 SPANISH FORK, UT 84660

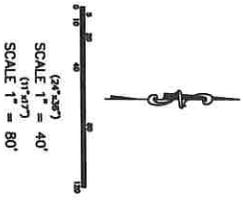**GRADING PLAN**  
**DRYLAND SUBDIVISION**  
**ELK RIDGE, UTAH**


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SHEET NO.  
**4**

T:\PROJECTS\14-003\_Huskell\_Plv\_Edge\CADD\FROM 104-GRADING.dwg 12/30/2010 2:38:32 PM NCT


NOTES: UNLESS OTHERWISE NOTED, ALL LOT AREA DESIGNATIONS ARE TO BE CONSIDERED AS APPROXIMATE. THE CONTRACTOR SHALL BE RESPONSIBLE FOR OBTAINING ALL NECESSARY PERMITS AND APPROVALS FROM THE LOCAL GOVERNMENT. THE CONTRACTOR SHALL BE RESPONSIBLE FOR OBTAINING ALL NECESSARY PERMITS AND APPROVALS FROM THE LOCAL GOVERNMENT. THE CONTRACTOR SHALL BE RESPONSIBLE FOR OBTAINING ALL NECESSARY PERMITS AND APPROVALS FROM THE LOCAL GOVERNMENT.

HENRY & RENEE GOODNOW  
30-073-0224

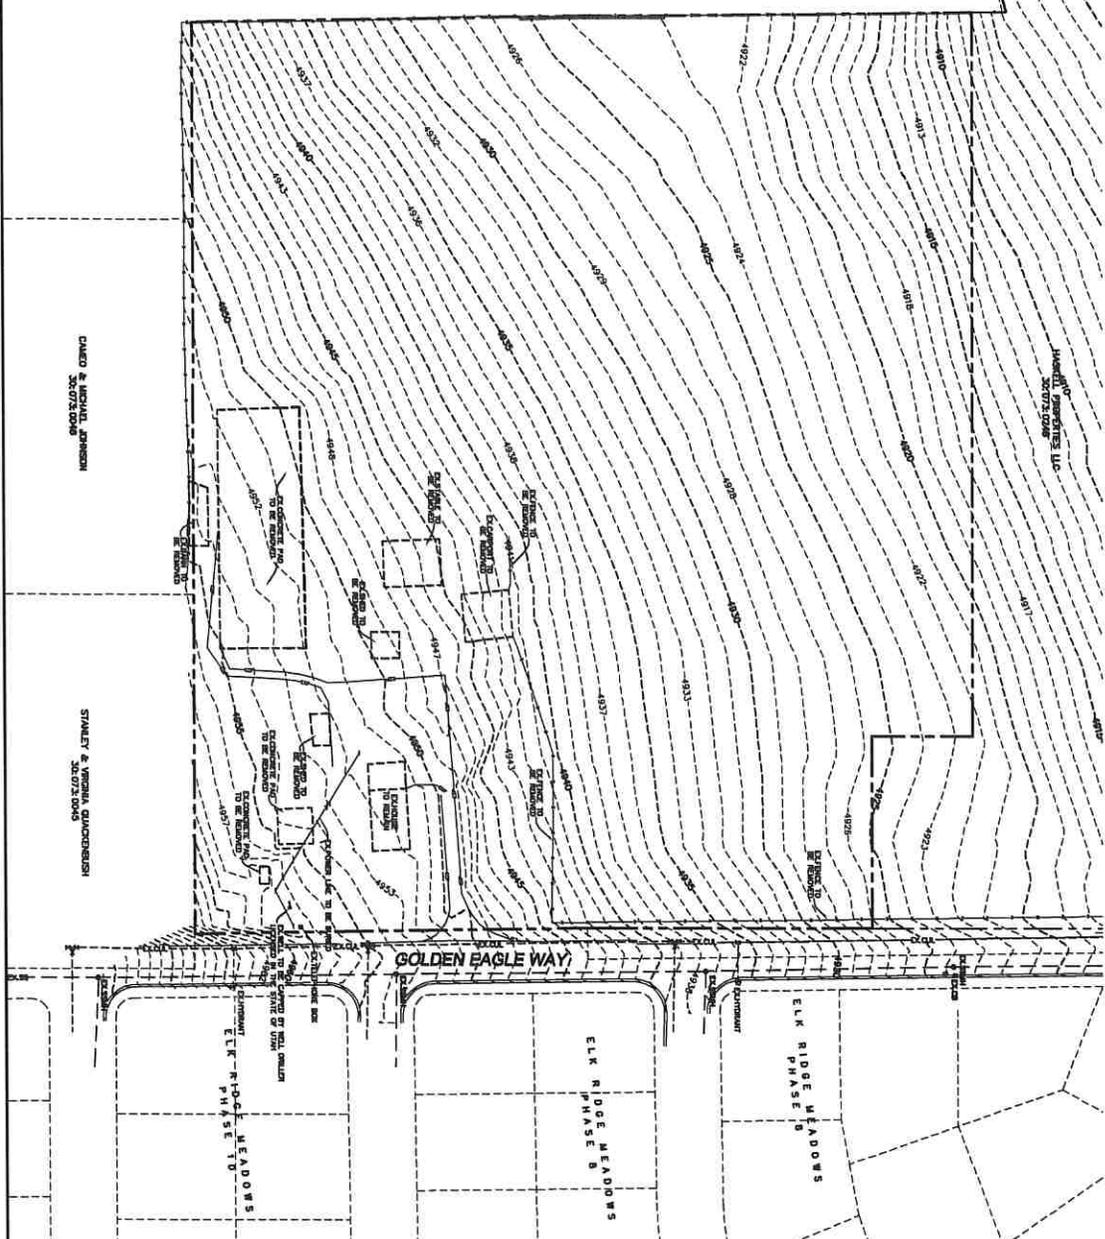

DAVID & MICHAEL JOHNSON  
30-073-0206

STANLEY & VERENA GUARDENSISH  
30-073-0240

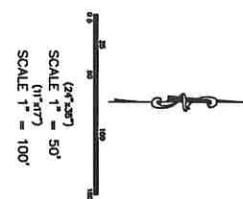

**OWNER/DEVELOPER**  
LEE HASKELL  
3001 S. 1000 E. SUITE 100  
ELK RIDGE, UTAH 84120  
801-372-0139

**DATA TABLE**  
ZONE CLASSIFICATION-R-1-20  
TOTAL # OF LOTS=15  
ACREAGE IN ROADS=178 ACRES  
ACREAGE IN LOTS=93.32 ACRES



**ATLAS ENGINEERING LLC.**  
PHONE: 801-655-0566  
FAX: 801-655-0100  
946 E 800 N SUITE A  
SPANISH FORK, UT 84660

EXISTING TOPOGRAPHY  
DRYLAND SUBDIVISION  
ELK RIDGE, UTAH



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SHEET NO.  
5

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EROSION CONTROL PLAN  
DRYLAND SUBDIVISION  
ELK RIDGE, UTAH

**ATLAS ENGINEERING LLC**  
 1000 S. 1000 E. SUITE 100  
 P.O. BOX 1000  
 SPARSH POND, UT 84080  
 PHONE: 801-485-0289  
 FAX: 801-485-0108  
 5410 E. 800 N. SUITE A



STANLEY & VIRGINIA QUANDREIGH  
30-073-0048

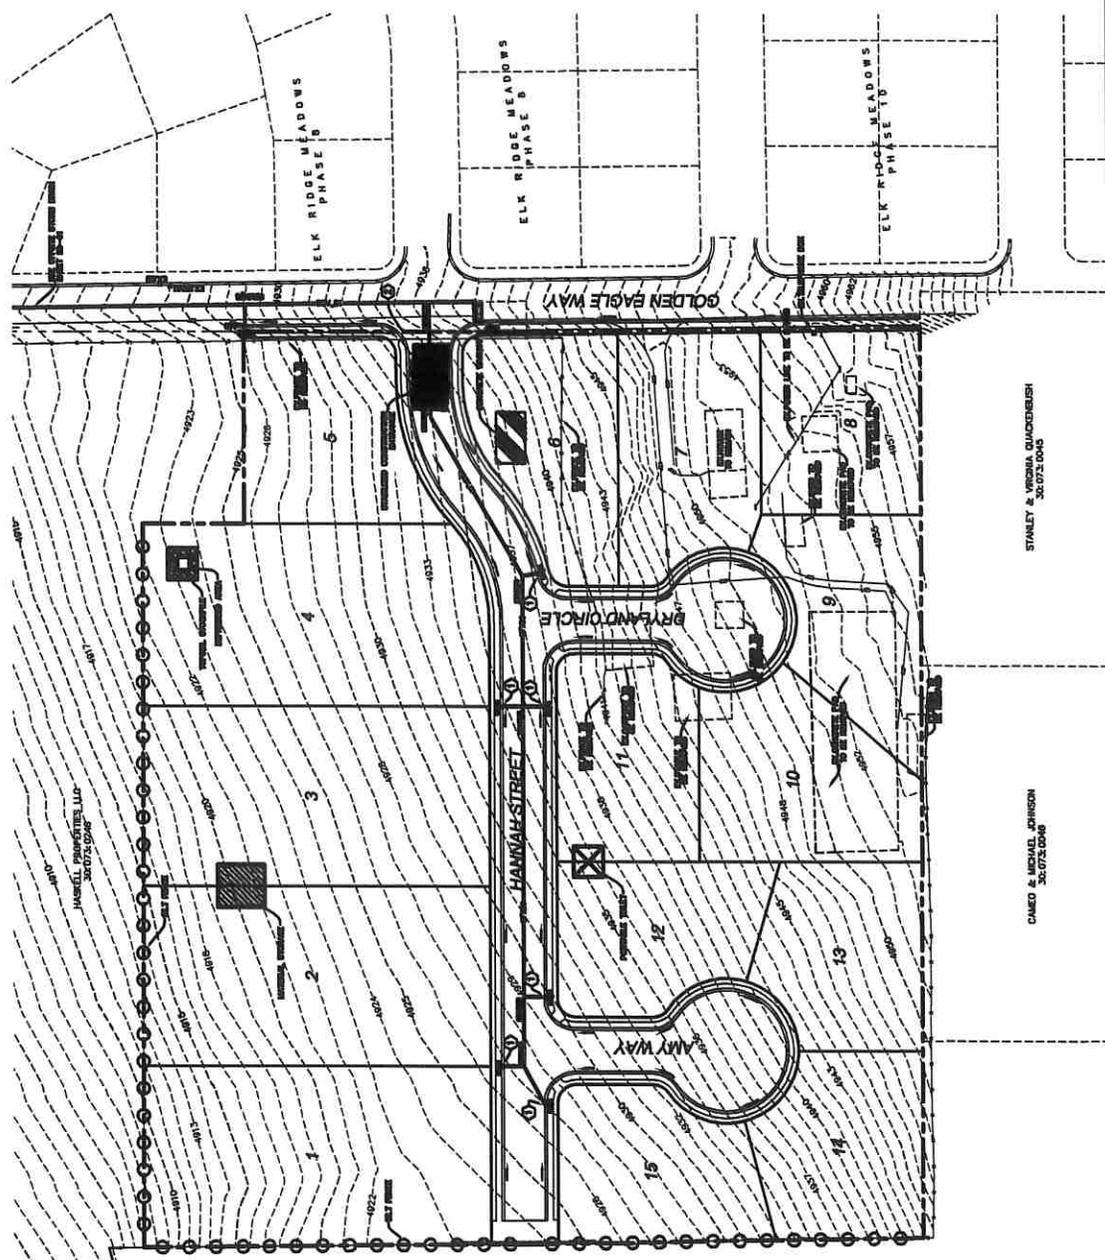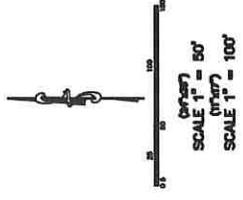CAROL & MICHAEL JOHNSON  
30-073-0048

HENRY & NIKKI GOODNOW  
30-073-0024

- LEGEND**
- 1. CHECK DAM
  - 2. SILT FENCE
  - 3. SEDIMENT BASIN
  - 4. EROSION CONTROL STRUCTURE
  - 5. CONSTRUCTION FENCE
  - 6. CONSTRUCTION FENCE WITH SIGNAGE
  - 7. CONSTRUCTION FENCE WITH SIGNAGE AND SPINNY DISK
  - 8. SPINNY DISK
  - 9. SPINNY DISK WITH SIGNAGE
  - 10. SPINNY DISK WITH SIGNAGE AND SPINNY DISK
  - 11. SPINNY DISK WITH SIGNAGE AND SPINNY DISK WITH SIGNAGE
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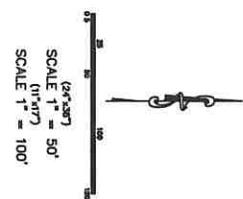
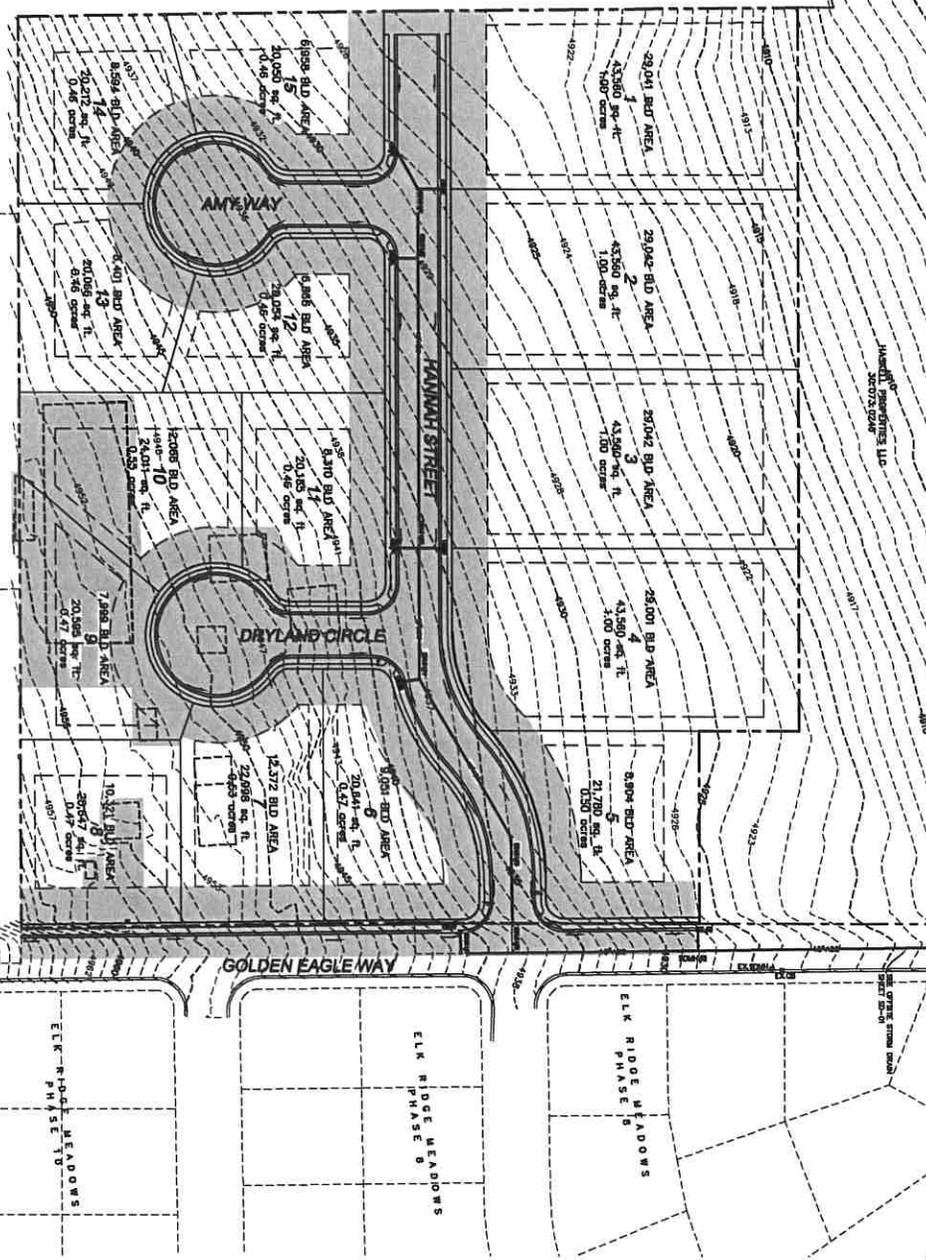
NOTES:  
 1. THE EROSION CONTROL PLAN SHALL BE CONSIDERED A PART OF THE SUBDIVISION MAP AND SHALL BE FILED WITH THE COUNTY CLERK'S OFFICE.  
 2. THE EROSION CONTROL PLAN SHALL BE CONSIDERED A PART OF THE SUBDIVISION MAP AND SHALL BE FILED WITH THE COUNTY CLERK'S OFFICE.  
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HENRY & RENEE GOODNOW  
30-073-0224

NOTES:  
1. THE AREAS ARE NOT TO SCALE.  
2. THE AREAS ARE NOT TO SCALE.

CAROL & MICHAEL JENSEN  
30-073-0046

STANLEY & VIRGINIA QUIGGINS  
30-073-0045



**ATLAS  
ENGINEERING  
L.L.C.**

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SPANISH FORK, UT 84660

RE-VEGETATION/RETENTION  
PLAN


DRYLAND SUBDIVISION  
ELK RIDGE, UTAH

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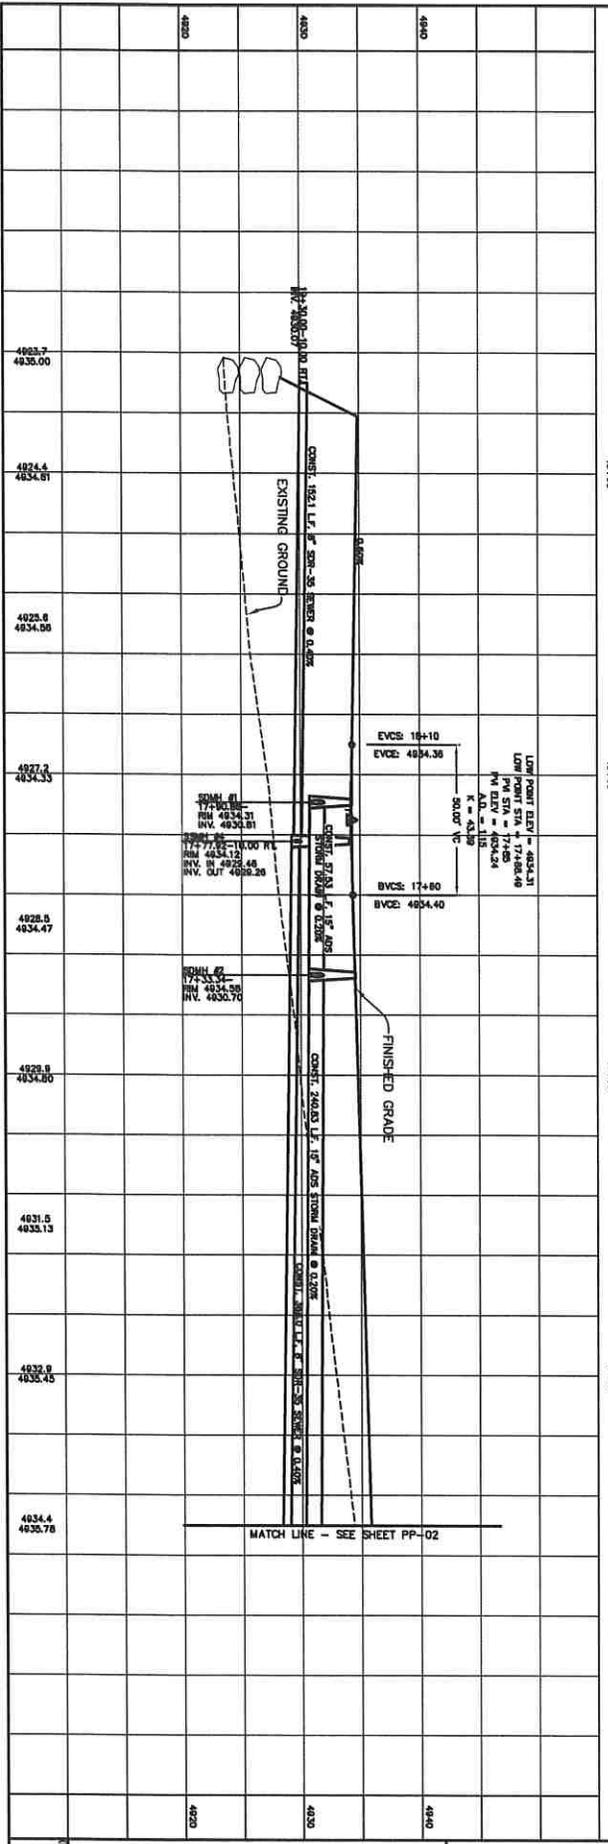
7

SCALE 1" = 20'  
SCALE 1" = 40'



GENERAL NOTES:  
 ALL CURB INLET BODIES REQUIRE A SLOPE OF 0.5% TO THE STREET AND MUST BE INSTALLED PER SHOOT MANUFACTURER'S RECOMMENDATION.

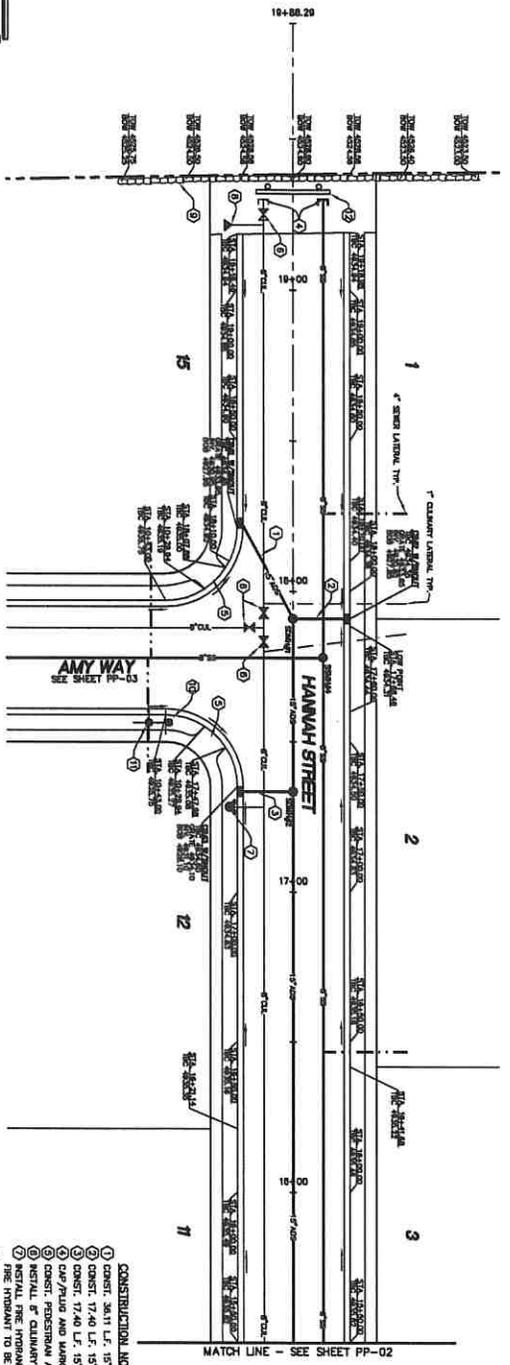- CONSTRUCTION NOTES:
- 1) CONST. 36.11 L.F. 15' AOS @ 0.3%
  - 2) CONST. 17.40 L.F. 15' AOS @ 0.23%
  - 3) CONST. 17.40 L.F. 15' AOS @ 2.20%
  - 4) CUR/PADA AND MARK TO SURFACE
  - 5) CONST. PERISTEMA ACCESS WAFF PER ELK RIDGE CITY STANDARDS
  - 6) INSTALL PERISTEMA ASSEMBLY PER ELK RIDGE CITY STANDARDS
  - 7) PERISTEMA PERMANENTLY MARKED
  - 8) PERISTEMA TO BE EAST SIDE
  - 9) INSTALL TEMPORARY BELOW OFF VALVE PER ELK RIDGE CITY STANDARDS
  - 10) INSTALL STOP SIGN PER ELK RIDGE CITY STANDARDS
  - 11) INSTALL STREET SIGN PER ELK RIDGE CITY STANDARDS
  - 12) INSTALL END OF STREET CHEVRON MARKERS





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 948 E. 800 N. SUITE A  
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HANNAH STREET  
 STA. 15+50 TO STA. 19+88.29  
 DRYLAND SUBDIVISION  
 ELK RIDGE, UTAH

| NO. | REVISIONS | BY | DATE |
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SHEET NO.  
**PP-01**



SCALE 1" = 20'  
SCALE 1" = 40'

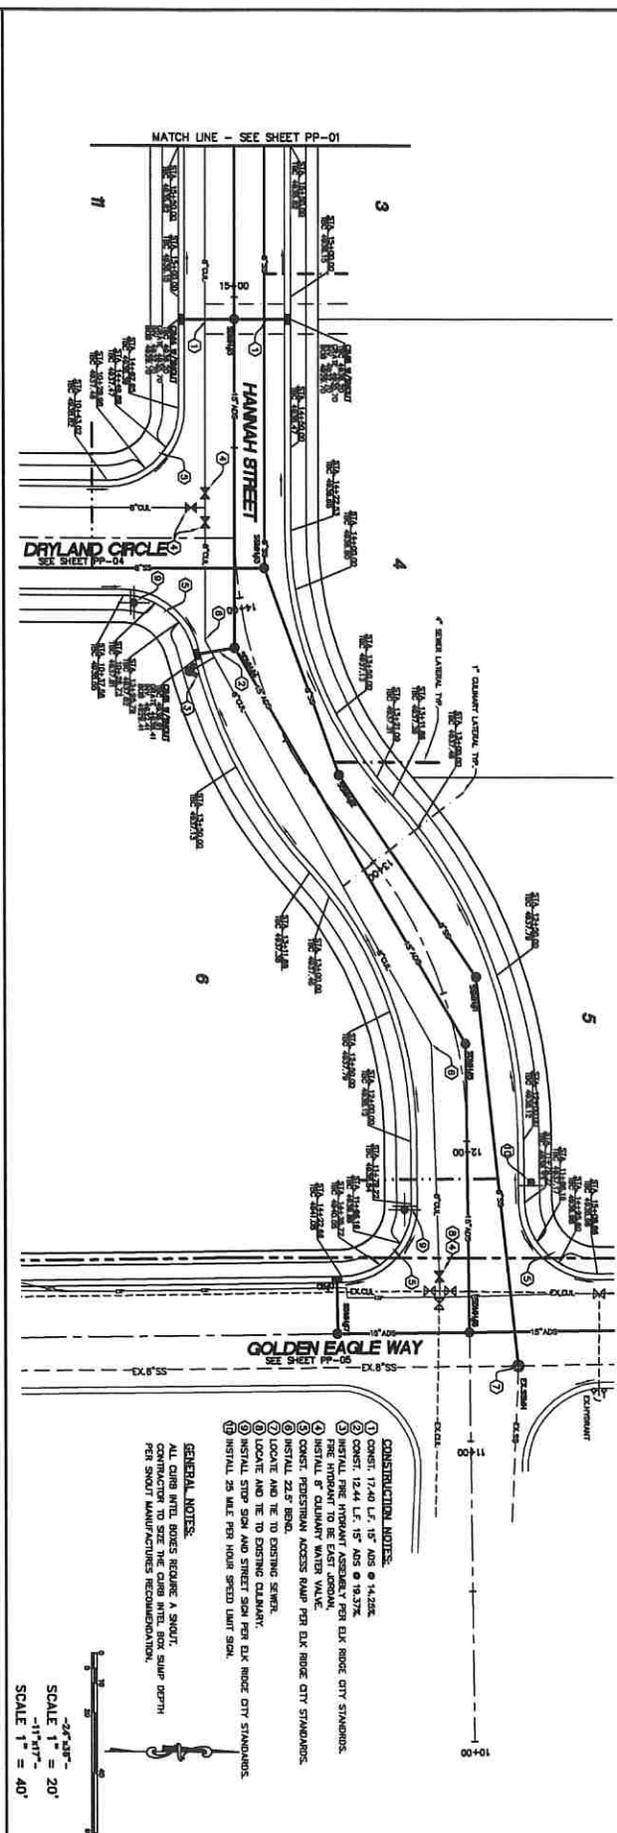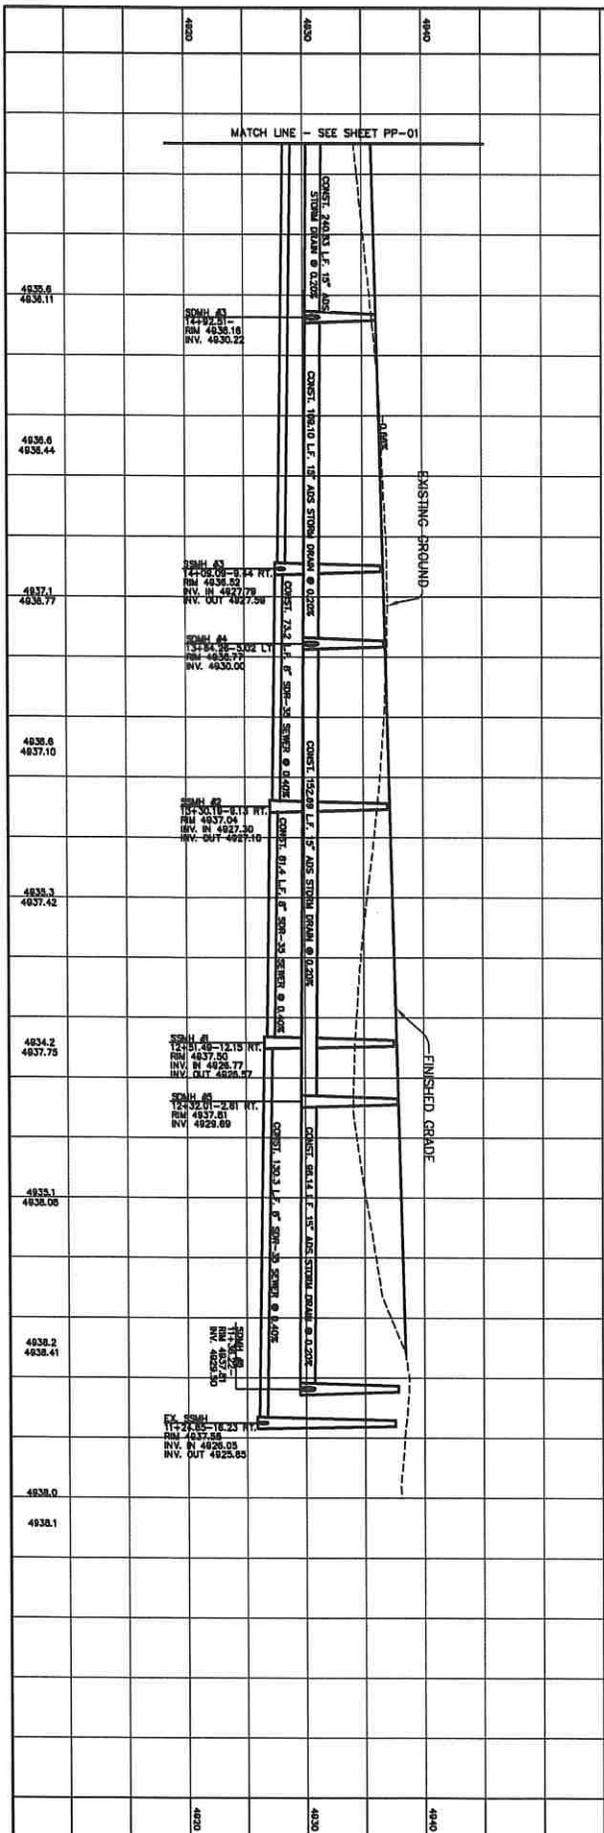- CONSTRUCTION NOTES:**
1. CONST. 17.40 L.F. 15" ASB @ 14.22K.
  2. CONST. 12.44 L.F. 15" ASB @ 18.37K.
  3. INSTALL FINE HYDRANT ASSEMBLY PER ELK RIDGE CITY STANDARDS.
  4. FINE HYDRANT TO BE EAST LEGION.
  5. INSTALL 8" CONCRETE WATER MAIN PER ELK RIDGE CITY STANDARDS.
  6. CONCRETE ACCESS MANHOLE PER ELK RIDGE CITY STANDARDS.
  7. INSTALL 22" FIBER OPTIC TO ENGINEERING CENTER.
  8. LOCATE AND TIE TO ENGINEERING CENTER.
  9. LOCATE AND TIE TO ENGINEERING CENTER.
  10. INSTALL STOP SIGN AND STREET SIGN PER ELK RIDGE CITY STANDARDS.
  11. INSTALL 25 MPH PER HOUR SPEED LIMIT SIGN.

**GENERAL NOTES:**

ALL CURB AND GUTTERS REQUIRE A SHOULDER STOP SIGN PER ELK RIDGE CITY STANDARDS. PER SHOOT MANUFACTURER'S RECOMMENDATION.

**ATLAS ENGINEERING L.L.C.**



PHONE: 801-655-0566  
FAX: 801-655-0109  
946 E. 600 N. SUITE A  
SPANISH FORK, UT 84660

HANNAH STREET  
STA. 10+00 TO STA. 15+50

DRYLAND SUBDIVISION  
ELK RIDGE, UTAH

SHEET NO.  
**PP-02**

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- CONSTRUCTION NOTES:**
- 1 CONST. PERMANENT ACCESS RAMP PER ELK RIDGE CITY STANDARDS.
  - 2 INSTALL FIRE HYDRANT ASSEMBLY PER ELK RIDGE CITY STANDARDS.
  - 3 PREPARE TO BE EAST JORDAN.
  - 4 INSTALL CURB/PAVEMENT BARRIER VALVE.
  - 5 INSTALL SLOPE OF VALVE.
  - 6 CURB/PAVEMENT MARK TO SURFACE.

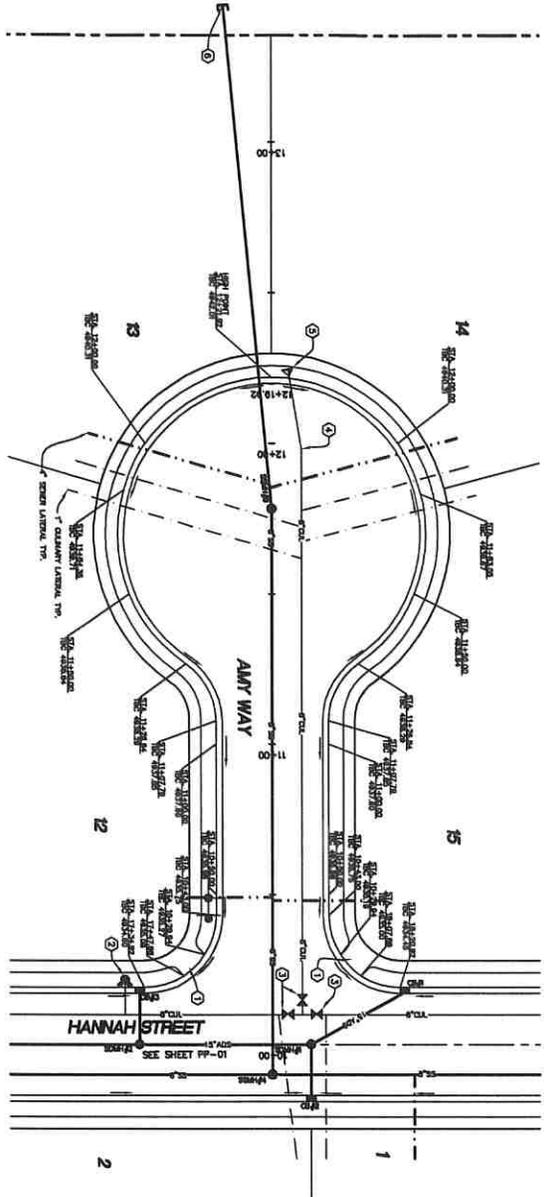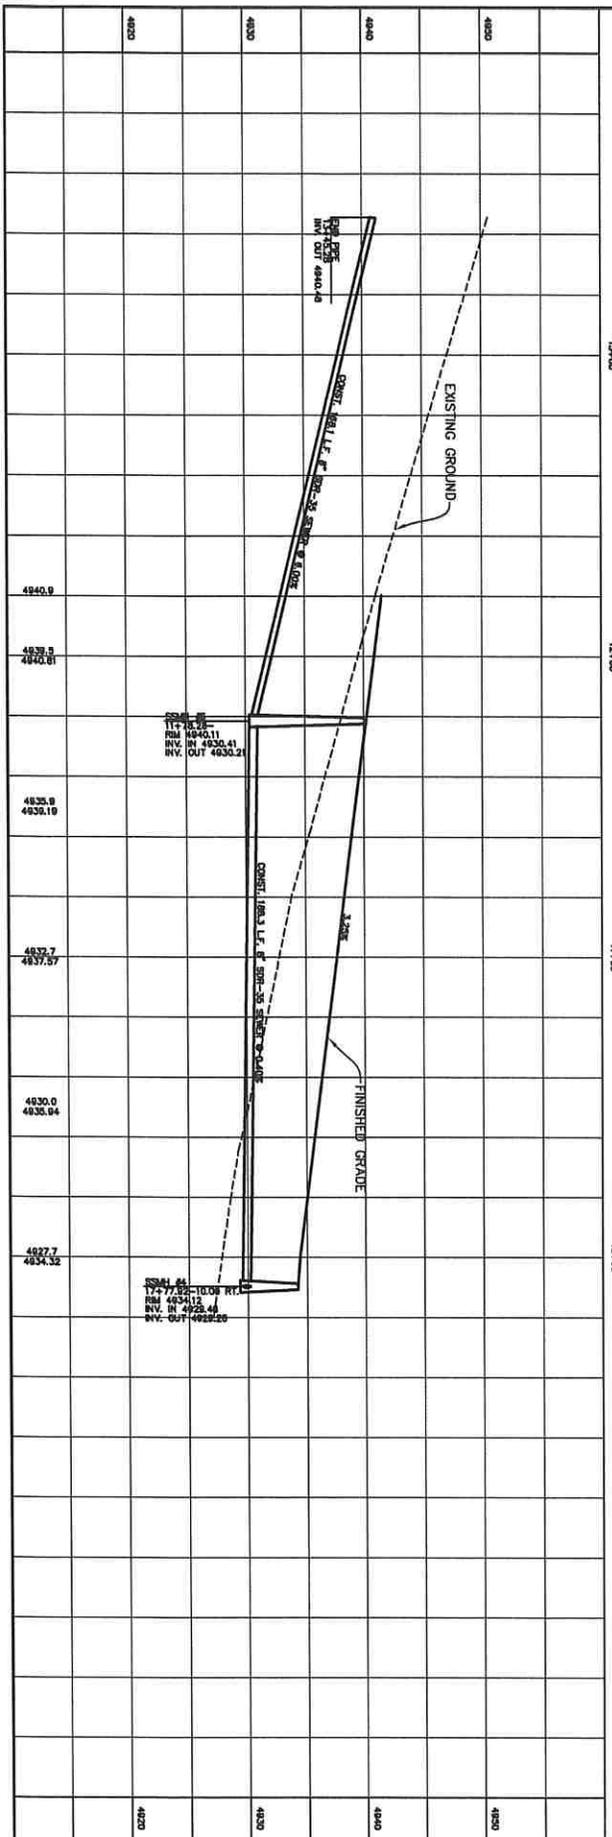-24" CURB-  
 SCALE 1" = 20'  
 -11" x 17"-  
 SCALE 1" = 40'





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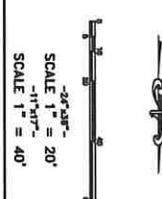
AMY WAY  
 STA. 10+00 TO STA. 13+50  
 DRYLAND SUBDIVISION  
 ELK RIDGE, UTAH

SHEET NO.  
**PP-03**

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- CONSTRUCTION NOTES:**
1. INSTALL FIRE HYDRANT ASSEMBLY PER ELK RIDGE CITY STANDARDS.
  2. INSTALL 1" GALVANIZED IRON WATER VALVE.
  3. CONECT. PROVISIONAL ACCESS PUMP PER ELK RIDGE CITY STANDARDS.
  4. INSTALL 22" BEND.
  5. INSTALL 45° BEND.
  6. INSTALL BLOW OFF VALVE.

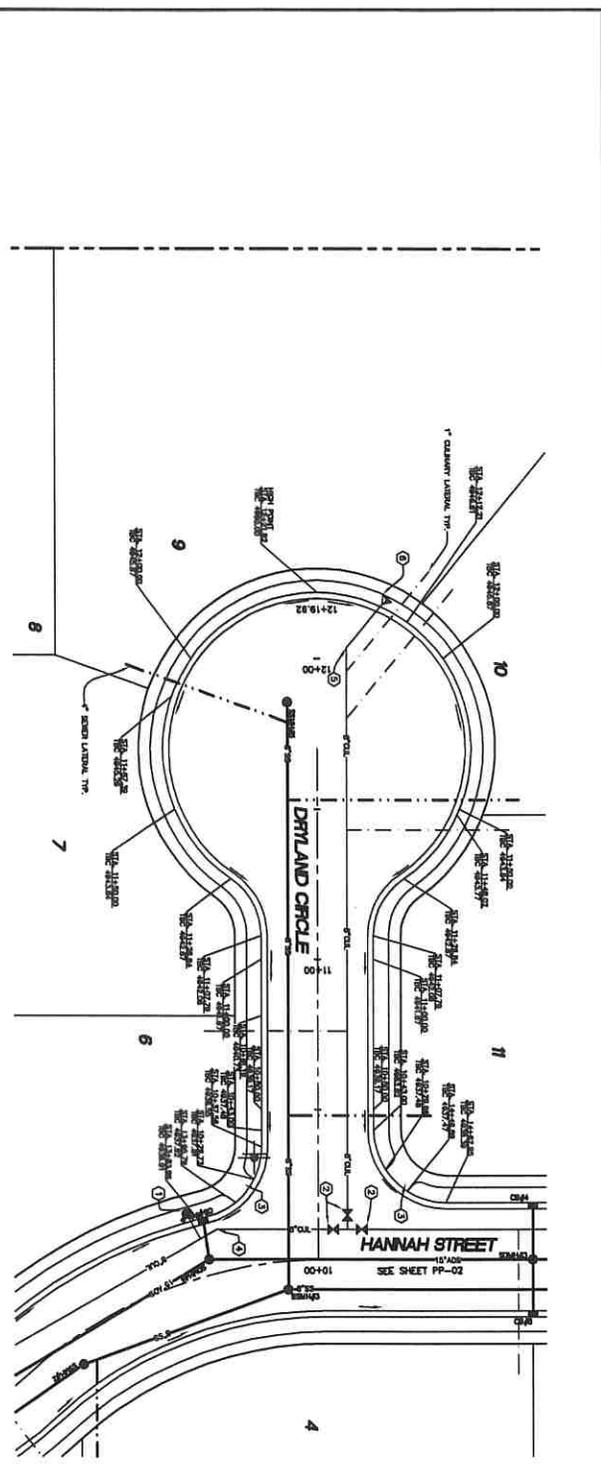
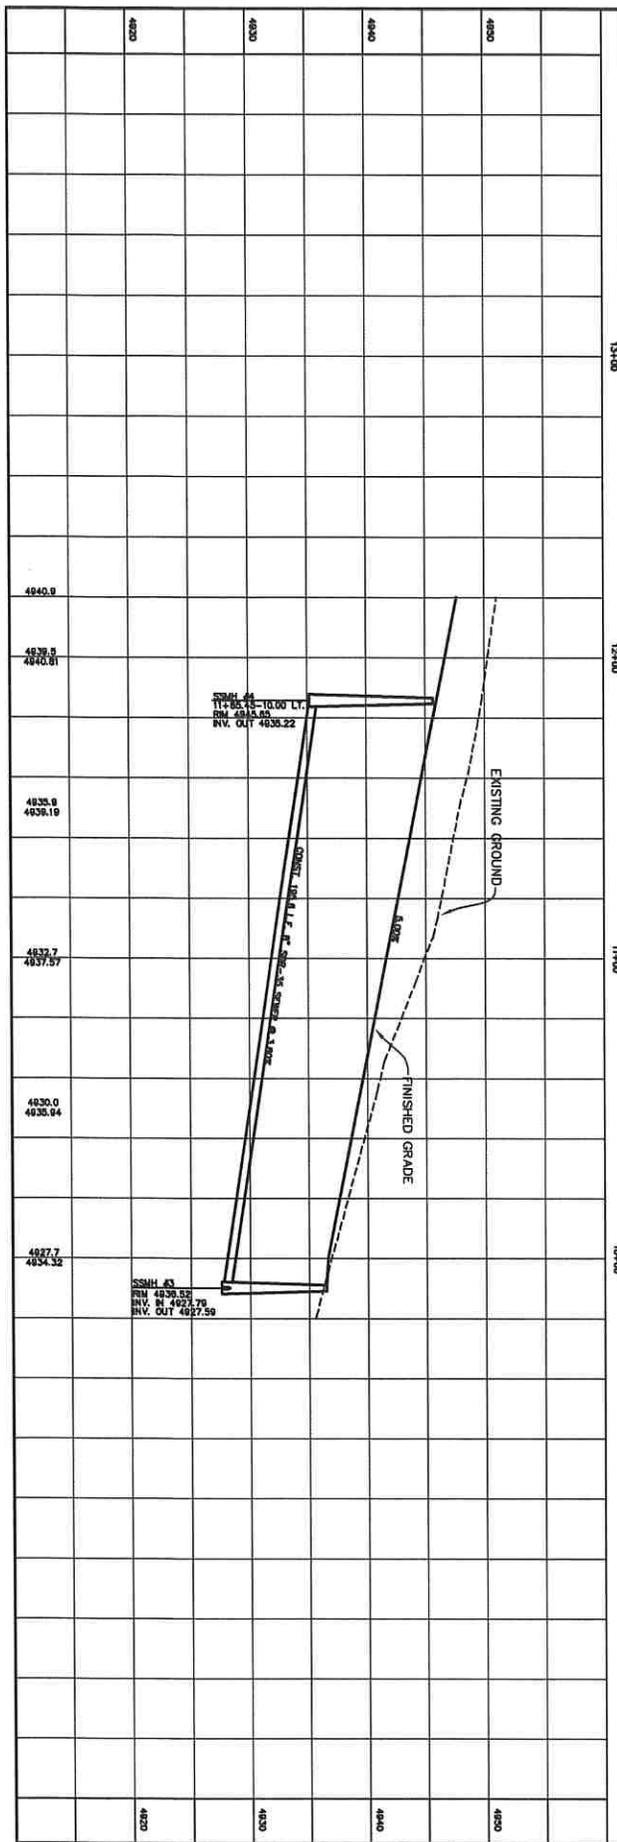



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LOIS LANE  
 STA. 10+00 TO STA. 12+19.92  
 DRYLAND SUBDIVISION  
 ELK RIDGE, UTAH


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SHEET NO. PP-04  
 20201013-001



- CONSTRUCTION NOTES:**
1. CONST. 17'40' L.F. 15' NOS @ 2.0%.
  2. INSTALL STOP SIGN PER EX. RIDGE CITY STANDARDS.
  3. LOCATE AND TIE TO EXISTING SURVEY.
  4. LOCATE AND TIE TO EXISTING SURVEY.
  5. CONST. PROVISIONAL ACCESS RAMP PER EX. RIDGE CITY STANDARDS.
  6. CONST. 17'40' L.F. 15' NOS @ 2.0%.

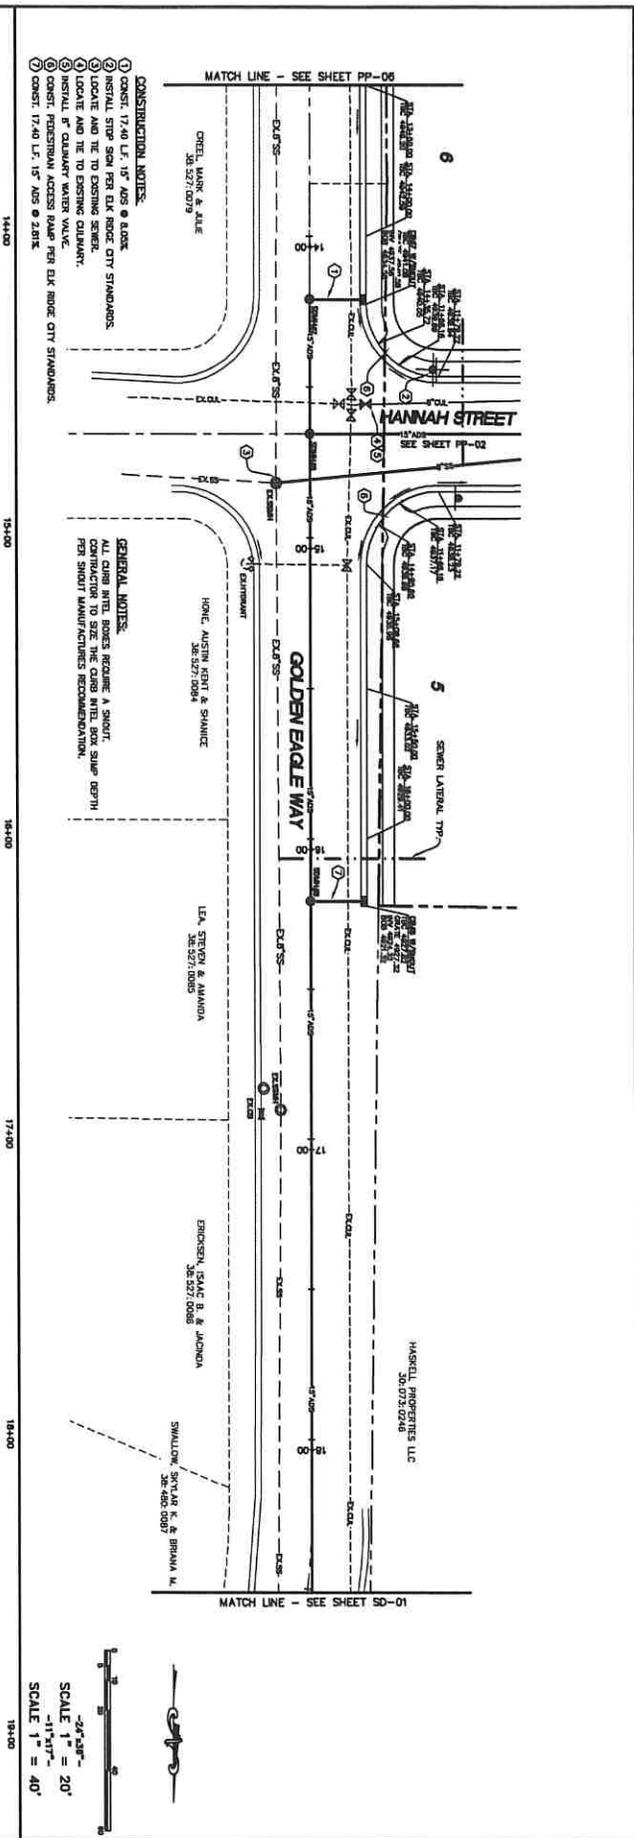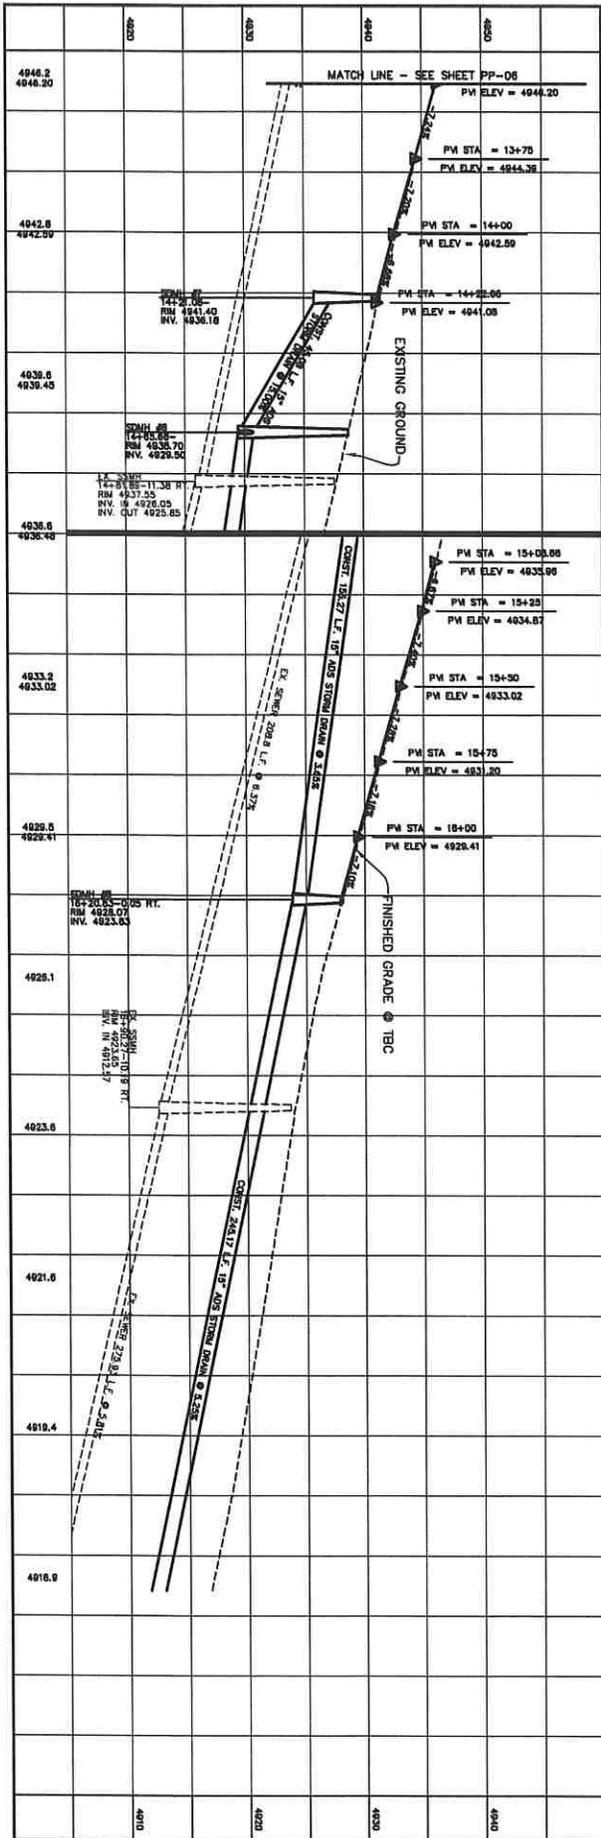- GENERAL NOTES:**
- ALL CURB WHEEL BOWS REQUIRE A SLOPE.
  - CONTRACTOR TO SIZE THE CURB WHEEL BOW SUMP DEPTH PER SMOOT MANUFACTURER'S RECOMMENDATION.

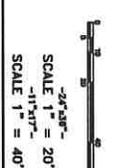

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GOLDEN EAGLE WAY  
 STA. 13+50 TO STA. 18+50



DRYLAND SUBDIVISION  
 ELK RIDGE, UTAH

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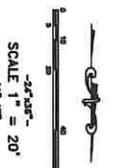
SHEET NO.  
**PP-05**

7/20/13 13:11:01 Plot File: D:\proj\13\13-05\13-05.dwg 12/20/2013 3:52:24 PM 1/27



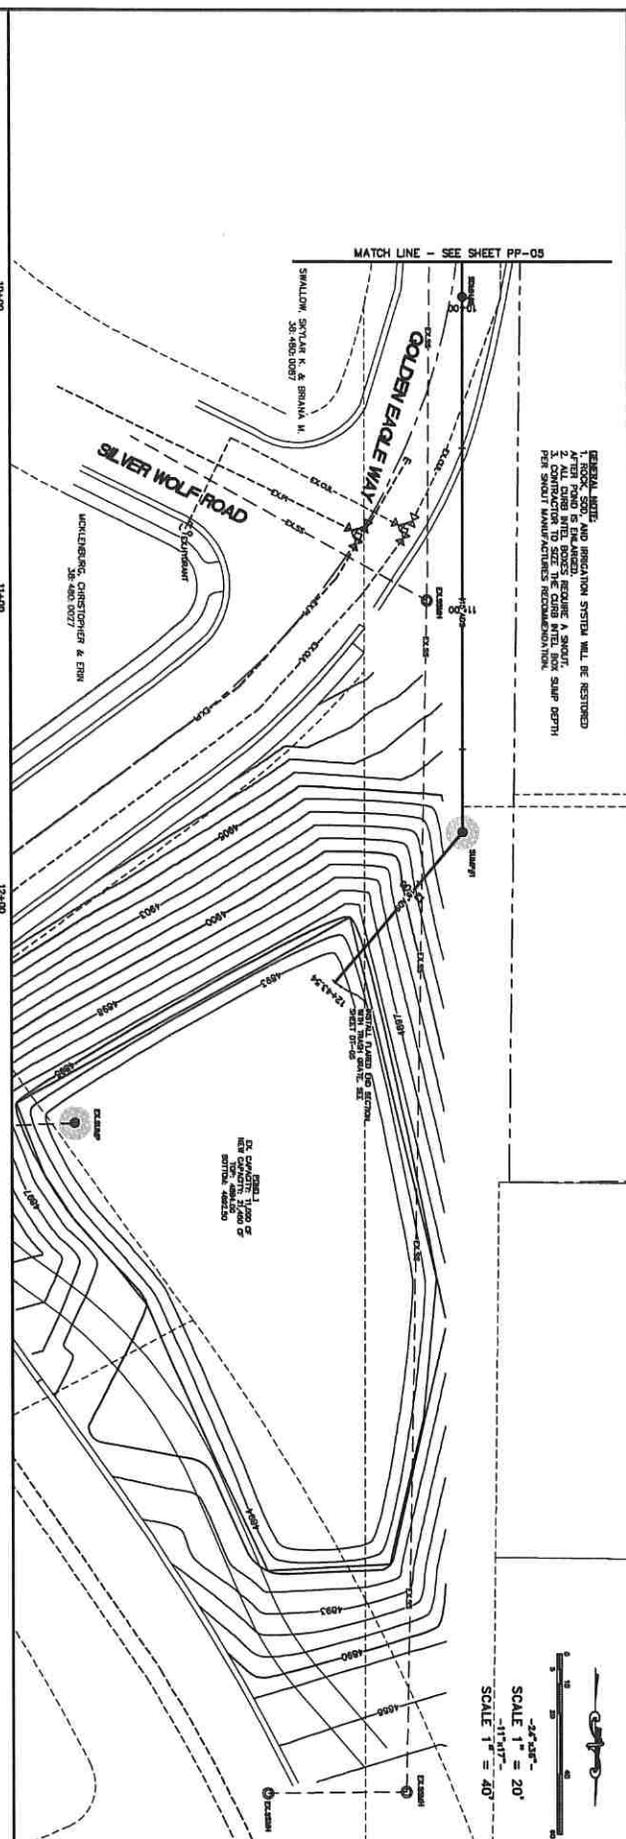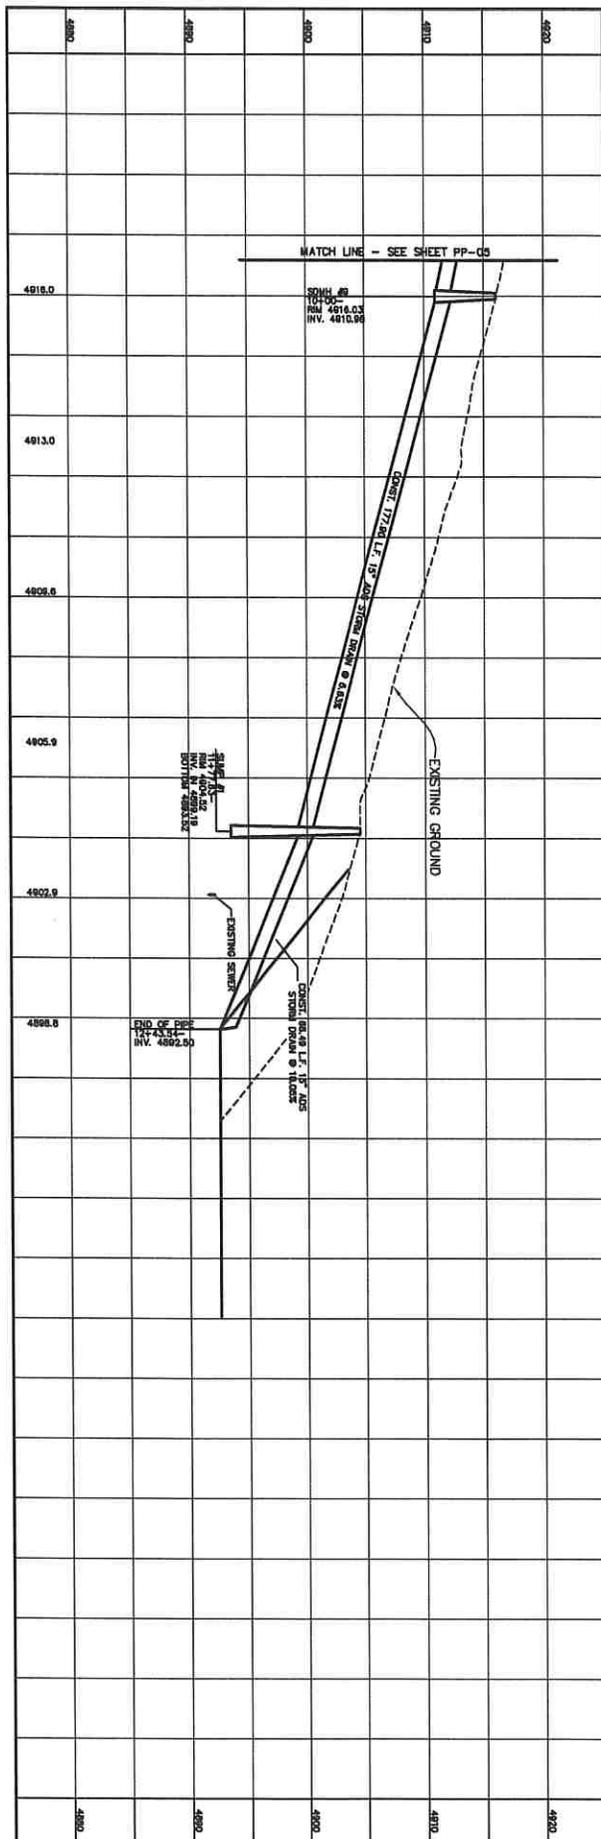

GENERAL NOTE:  
 1. ALL EXISTING AND PROPOSED SYSTEMS WILL BE RESTORED  
 AFTER FUND IS DEPLETED.  
 2. CONSTRUCTION SHALL BE IN ACCORDANCE WITH THE  
 UTAH CONSTRUCTION CODE AND THE UTAH STATE  
 PERMITS DIVISION'S RECOMMENDATION.




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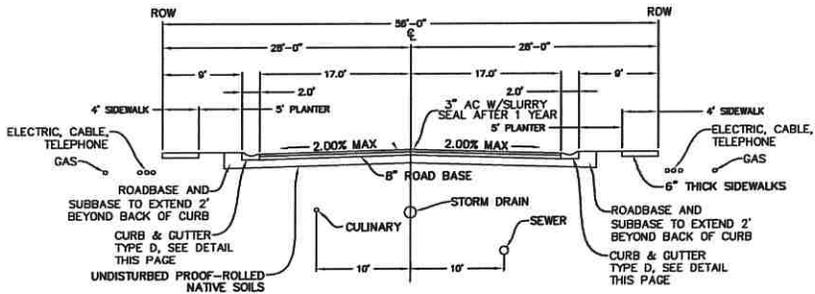
OFFSITE STORM DRAIN  
 STA. 10+00 TO STA. 12+43.54  
 HASKELL  
 ELK RIDGE, UTAH

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SHEET NO.  
**SD-01**




INTERIOR LOT  
CORNER LOT  
DETAIL - TYPICAL BUILDING SETBACK AND EASEMENT  
-NTS-

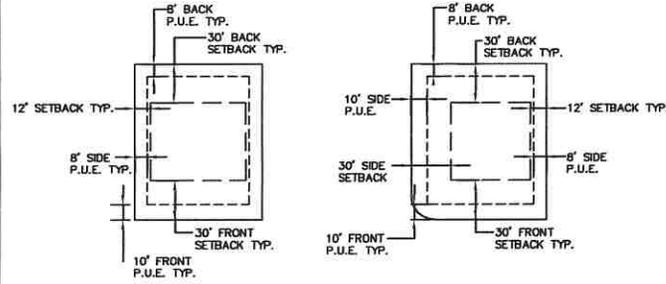

NOTES:  
1. ALL PAVEMENT DESIGN TO FOLLOW RECOMMENDATIONS OF GEOTECHNICAL REPORT PROJECT NO. 03278-001 BY IGES.  
2. BASED ON GEOTECH REPORT PROJECT NO. 03278-001 BY IGES, ONCE TOPSOIL IS STRIPPED, MOST OF THE NATIVE SOILS ARE SUITABLE TO BE USED AS SUB-BASE WHEN PROPERLY SCARIFIED AND COMPACTED. HOWEVER, LEAN CLAYS WERE ENCOUNTERED AT THE WEST SIDE OF THE PROJECT. LEAN CLAYS ARE NOT SUITABLE FOR SUB-BASE AND SHOULD BE REMOVED AND REPLACED WITH SUITABLE SUB-BASE MATERIAL PRIOR TO PLACING UNTREATED BASE COURSE.


DETAIL - TYPICAL 56' RIGHT-OF-WAY STREET SECTION  
-NTS-

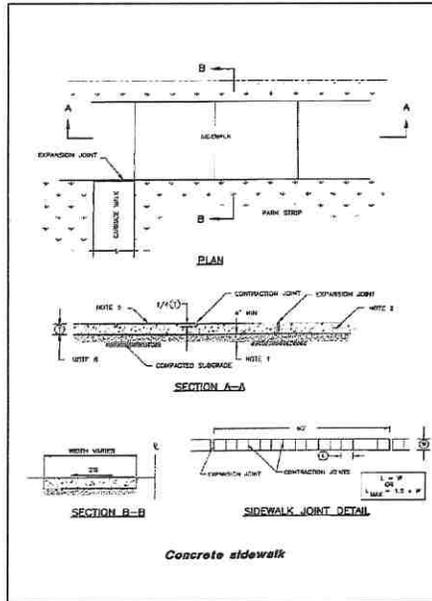

Concrete sidewalk

CONCRETE SIDEWALK STANDARD

- UNTREATED BASE COURSE: Provide material specified in APWA Section 02060. Do not use gravel or seiver rock. Place per APWA Section 02322. Compact per APWA Section 02224 to a modified proctor density of 95-percent or greater. Maximum lift thickness is 8-inches before compaction.
- CONCRETE: Class 4000 per APWA Section 03304. Place per APWA Section 02770. Cure per APWA Section 03390.
  - If necessary, provide concrete that achieves design strength in less than 7 days. Use caution, however, as spider cracks develop if air temperature exceeds 90 degrees F.
  - Unless shown otherwise, provide 1/2-inch radius on concrete edges exposed to public view.
- FINISH: Fine hair broom on longitudinal grades under 6% and rough hair broom on longitudinal grades over 6%.
- DEPTH OF SIDEWALK (T):
  - New construction: Nominal 6" in residential zones, 8" in non-residential zones.
  - Removal and replacement construction: Match existing.

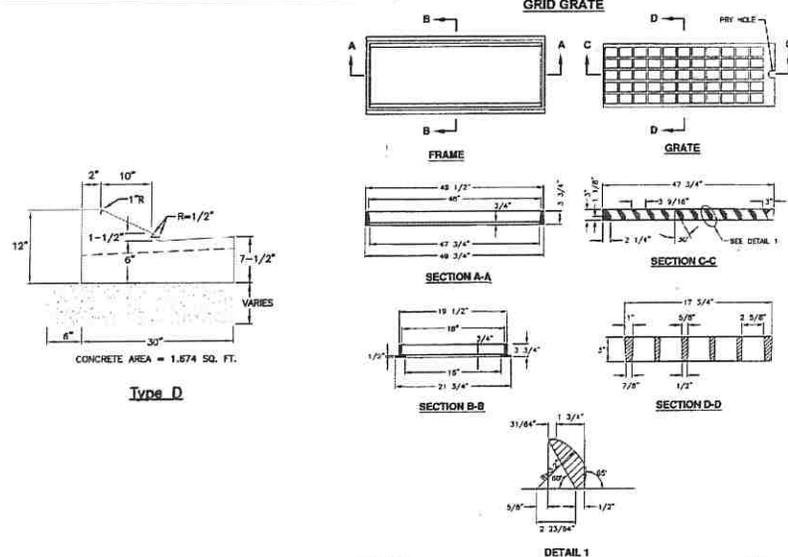

47 3/4" Grate and frame

Plan 309.2  
June 2016



SHEET NO. DT-01








DETAIL SHEET

DRYLAND SUBDIVISION  
ELK RIDGE, UTAH






ATLAS ENGINEERING L.L.C.

PHONE: 801-965-0686  
FAX: 801-965-0700  
8445 E 800 N SUITE A  
SPANISH FORK, UT 84660

DATE STAMP

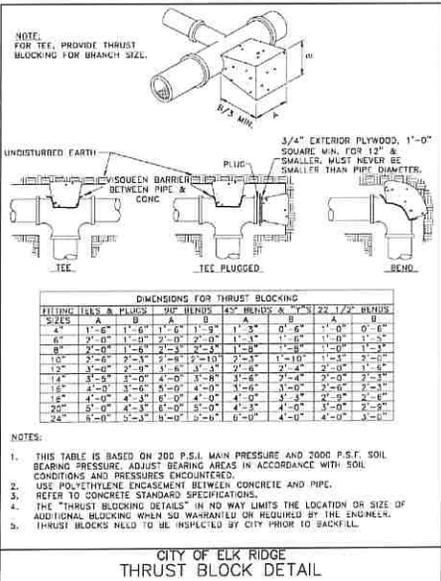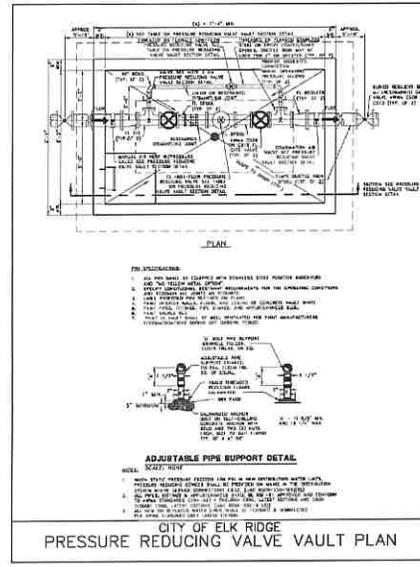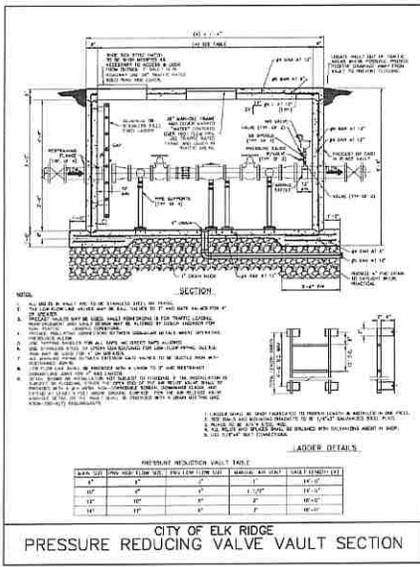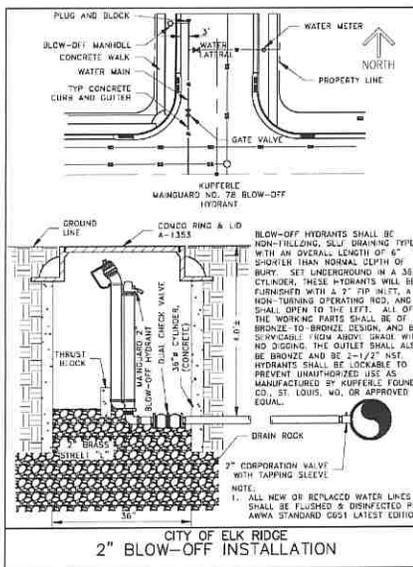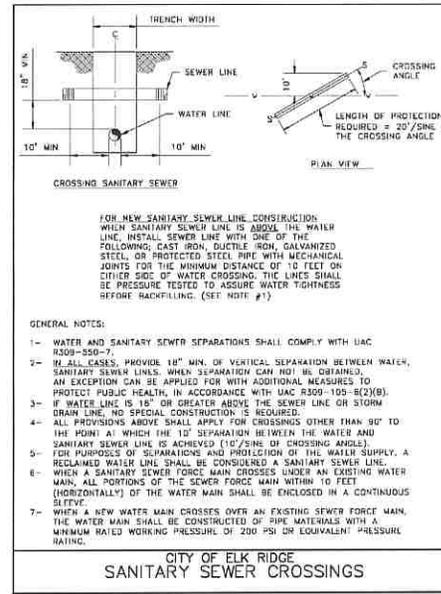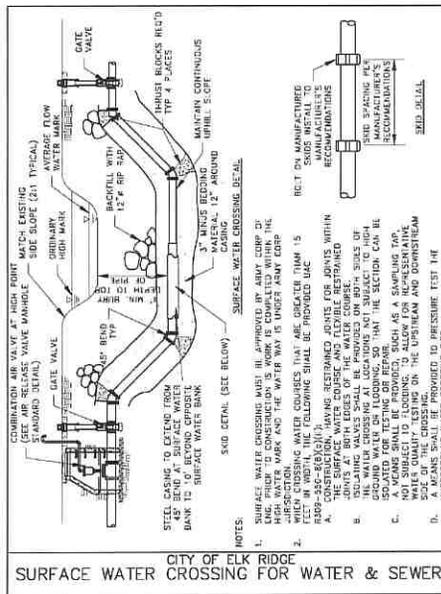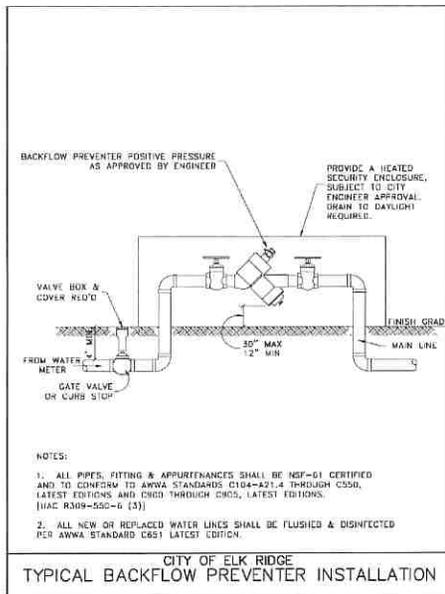

1. GENERAL
  - A. Vertical cleft in bituminous pavement may be done by saw or pavement stripping. If cuts greater than 6 inches are necessary to prevent pavement "break off" contact ENHANCER for directions on raveling and road cleft.
  - B. At the end of the work year, conditions shall be as follows:
    - 1) Pavement surface condition measures 1/4-inch deviation in 10 feet. Repair option - plan of surface distresses, coat-patched surface with a surface or elastic material that meets or exceeds the above.
    - 2) Separation appears at a connection to an existing pavement or any street feature. Repair option - leave separation clean and apply joint sealant, Plan 265.
    - 3) Cracks at least 1/4-inch long and 1/4-inch wide occur more often than 1 in 10 squares feet. Repair option - apply sealant, Plan 265.
    - 4) Pavement raveling is greater than 1 square foot per 100 square feet. Repair option - Mill and May, APWA Sections 32 01 16 71 and 32 12 05.
2. PRECURSORS
  - A. Base Course: Unexcavated base course, APWA Section 32 11 23. Do not use gravel as a base course without ENHANCER's permission.
  - B. Flexible Pav. Target is 60 PSI in 28 days with 90 psi maximum in 28 days, APWA Section 32 11 23.
  - C. Reinforcement: No. 5 galvanized or epoxy coated, conforming to bar yield grade steel ASTM A615.
  - D. Concrete: Class 4000, APWA Section 32 03 04.
  - E. Bituminous Concrete: APWA Section 32 12 05.
  - F. Warm Weather Patch: F-64-22-204-1/2 unless indicated otherwise.
  - G. Cold Weather Patch: Modified MC 250 F-64-1 as indicated in APWA Section 32 03 25.
3. EXECUTION
  - A. Base Course Placement: APWA Section 32 05 10. Maximum lift thickness before compaction is 8 inches when using paving equipment or 6 inches when using hand laid APWA Section 31 23 25. at 50 percent or greater relative to a passing No. 20 sieve.
  - B. Flexible Pav. Care to mill set before placing aggregate base or bituminous pavement. Use if excavations that are too narrow to receive compaction equipment. All surfaces shall be prepared in accordance with the above.
  - C. Reinforcement: Follow APWA Section 32 12 16.3. Unless indicated otherwise, lift thickness is 3 inches minimum after compaction. Conform to 84 percent of ASTM D2041 (Rat Density) table or more. 2 percent.
  - D. Bituminous Concrete: Bituminous concrete is substituted for Portland cement concrete substrate, over rebar and provide 1.25 inches of bituminous concrete for each 1 inch of Portland cement concrete. Follow paragraph E requirements.
  - E. Reinforcement: Required if in-place of existing Portland cement concrete substrate in 6 inch or greater depth. Reinforcement shall be placed in accordance with the above. Minimum 3/4" diameter, #3 if excavation is less than 3 feet square, or #4 if bituminous pavement is substituted for Portland cement concrete substrate.
  - F. Concrete Substrate: Care to mill set before placing new bituminous concrete patch.

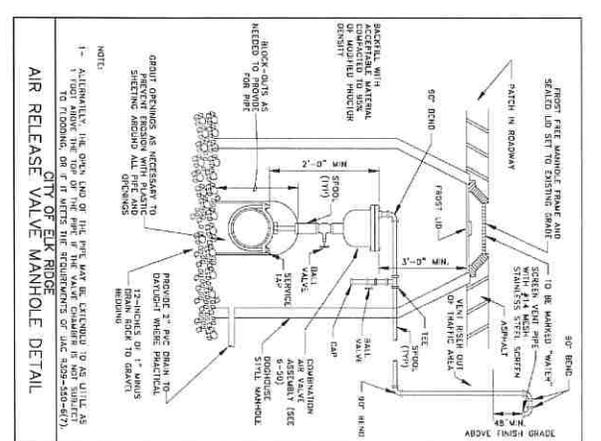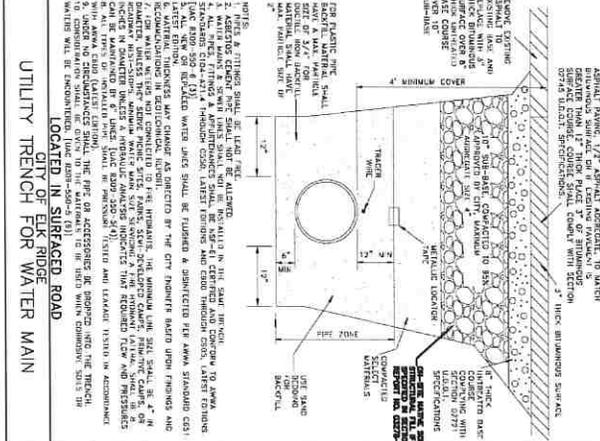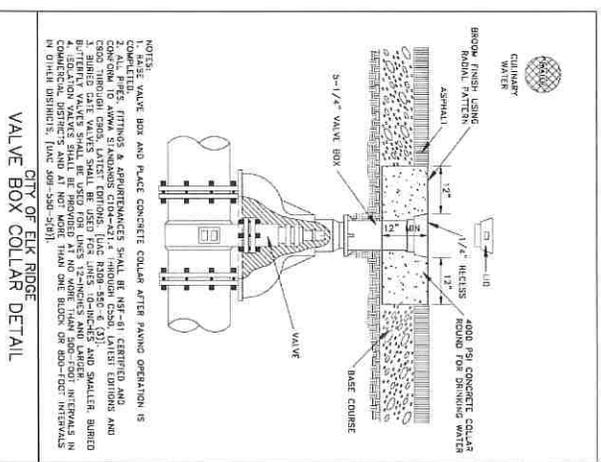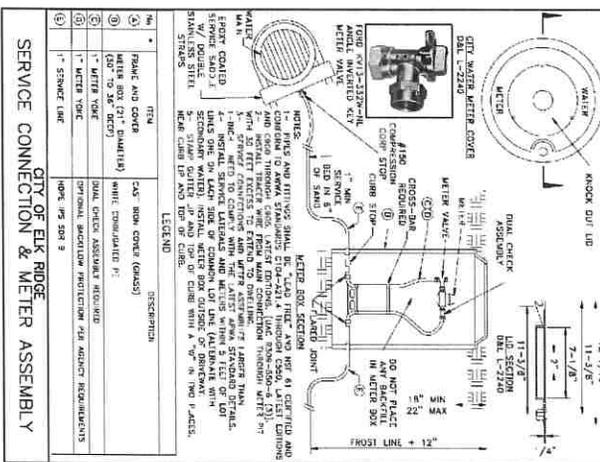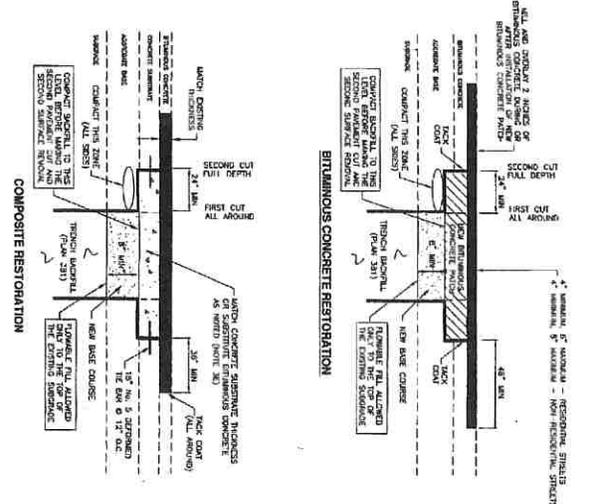

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DETAIL SHEET

DRYLAND SUBDIVISION

ELK RIDGE, UTAH


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**DT-03**

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**REINFORCED CONCRETE PIPE  
FLARED END SECTIONS**  
15" TO 36" I.D.



| DIA. | WALL   | TONGUE OR GROOVE | WEIGHT | A      | B       | C       | D       | E   |
|------|--------|------------------|--------|--------|---------|---------|---------|-----|
| 15"  | 2-1/4" | 1-3/4"           | 870    | 6"     | 22"     | 48"     | 73"     | 30" |
| 18"  | 2 1/2" | 1-3/4"           | 1340   | 9"     | 22"     | 48"     | 73"     | 36" |
| 24"  | 3"     | 1-3/4"           | 1820   | 9-1/2" | 43-1/2" | 30"     | 73-1/2" | 48" |
| 30"  | 4-1/4" | 3-7/8"           | 2400   | 12"    | 54"     | 19-3/4" | 73-3/4" | 60" |
| 36"  | 4-3/4" | 3-7/8"           | 3500   | 15"    | 63"     | 34-3/4" | 87-3/4" | 72" |


REINFORCED CONCRETE PIPE CONFORMS TO ASTM C-76, ASTM C-443, AASHTO M-170, AND AASHTO M-158.

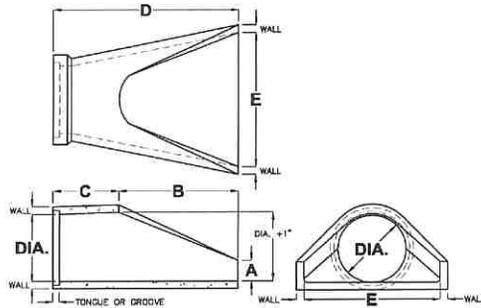FOR COMPLETE DESIGN AND PRODUCT INFORMATION CONTACT JENSEN PRECAST.

Jensen Precast reserves the right to make changes to product design and/or dimensions without notice. Please consult Jensen Precast's website for the most current information on product design.

1/9/2009  
RFP FLARED END SECTION\_RJKW\_AJW  
8550

**JENSEN  
PRECAST**

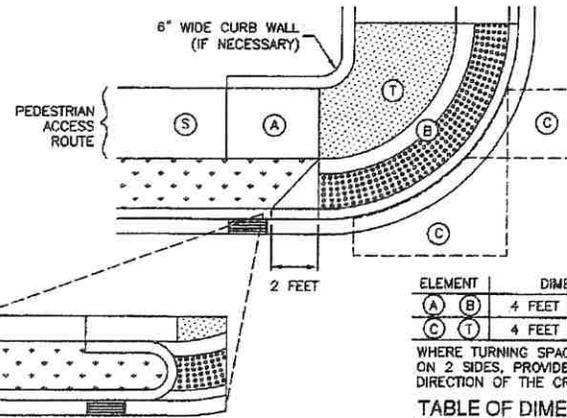

| ELEMENT | DIMENSION             |
|---------|-----------------------|
| (A) (B) | 4 FEET WIDE MINIMUM   |
| (C) (T) | 4 FEET SQUARE MINIMUM |


WHERE TURNING SPACE IS CONSTRAINED ON 2 SIDES, PROVIDE 5 FEET IN THE DIRECTION OF THE CROSSWALK

**TABLE OF DIMENSIONS**

|                        | RUNNING SLOPE (%) MAXIMUM | CROSS SLOPE (%) MAXIMUM |
|------------------------|---------------------------|-------------------------|
| TURNING SPACE (T)      | 2                         | 2                       |
| BLENDED TRANSITION (B) | 5                         | 2 (c)                   |
| CLEAR SPACE (C)        | 5                         | 2 (c)                   |
| SIDEWALK (S)           | STREET GRADE              | 2                       |
| FLARE (F)              | 10                        | —                       |
| APPROACH (A)           | 8.33                      | 2                       |

- (a) RUNNING SLOPE IS IN THE DIRECTION OF PEDESTRIAN TRAVEL. RUNNING SLOPE OF FLARE IS PARALLEL TO BACK OF CURB
- (b) CROSS SLOPE IS PERPENDICULAR TO DIRECTION OF PEDESTRIAN TRAVEL
- (c) SLOPE MAY EQUAL STREET OR HIGHWAY GRADE AT CROSSWALKS THAT ARE WITHOUT VEHICULAR YIELD OR STOP CONTROL

**SLOPE TABLE**

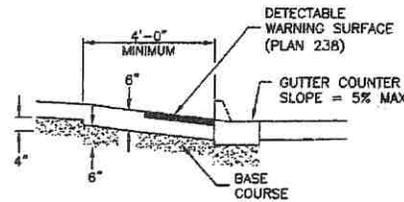

**MATERIALS**

**EXAMPLE C**



Corner curb cut assembly

Plan  
**235.2**  
September 2011

SHEET NO.  
**DT-05**

DETAIL SHEET  
DRYLAND SUBDIVISION  
ELK RIDGE, UTAH



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SPANISH FORK, UT 84660

(DATE, STAMP)





